# Village of Elk Rapids - Antrim County - Michigan

Sections 20 & 21, Township 29N, Range 09W


# **Owner**


**VILLAGE OF ELK RAPIDS MANAGER: JOHN MATTHEWS** P.O. BOX 398 315 BRIDGE STREET **ELK RAPIDS, MICHIGAN 49629** (231) 264-9971 - (231) 264-9274 jmatthews@elkrapids.org



# **Engineer**

**GOSLING CZUBAK ENGINEERING SCIENCES, INC.** 1280 BUSINESS PARK DRIVE **TRAVERSE CITY, MICHIGAN 49686-8607** (231) 946-9191 - (800) 968-1062 Fax: (231) 941-4603 www.goslingczubak.com

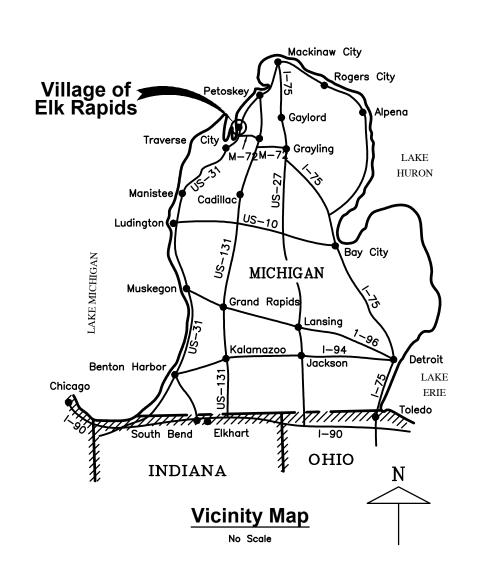

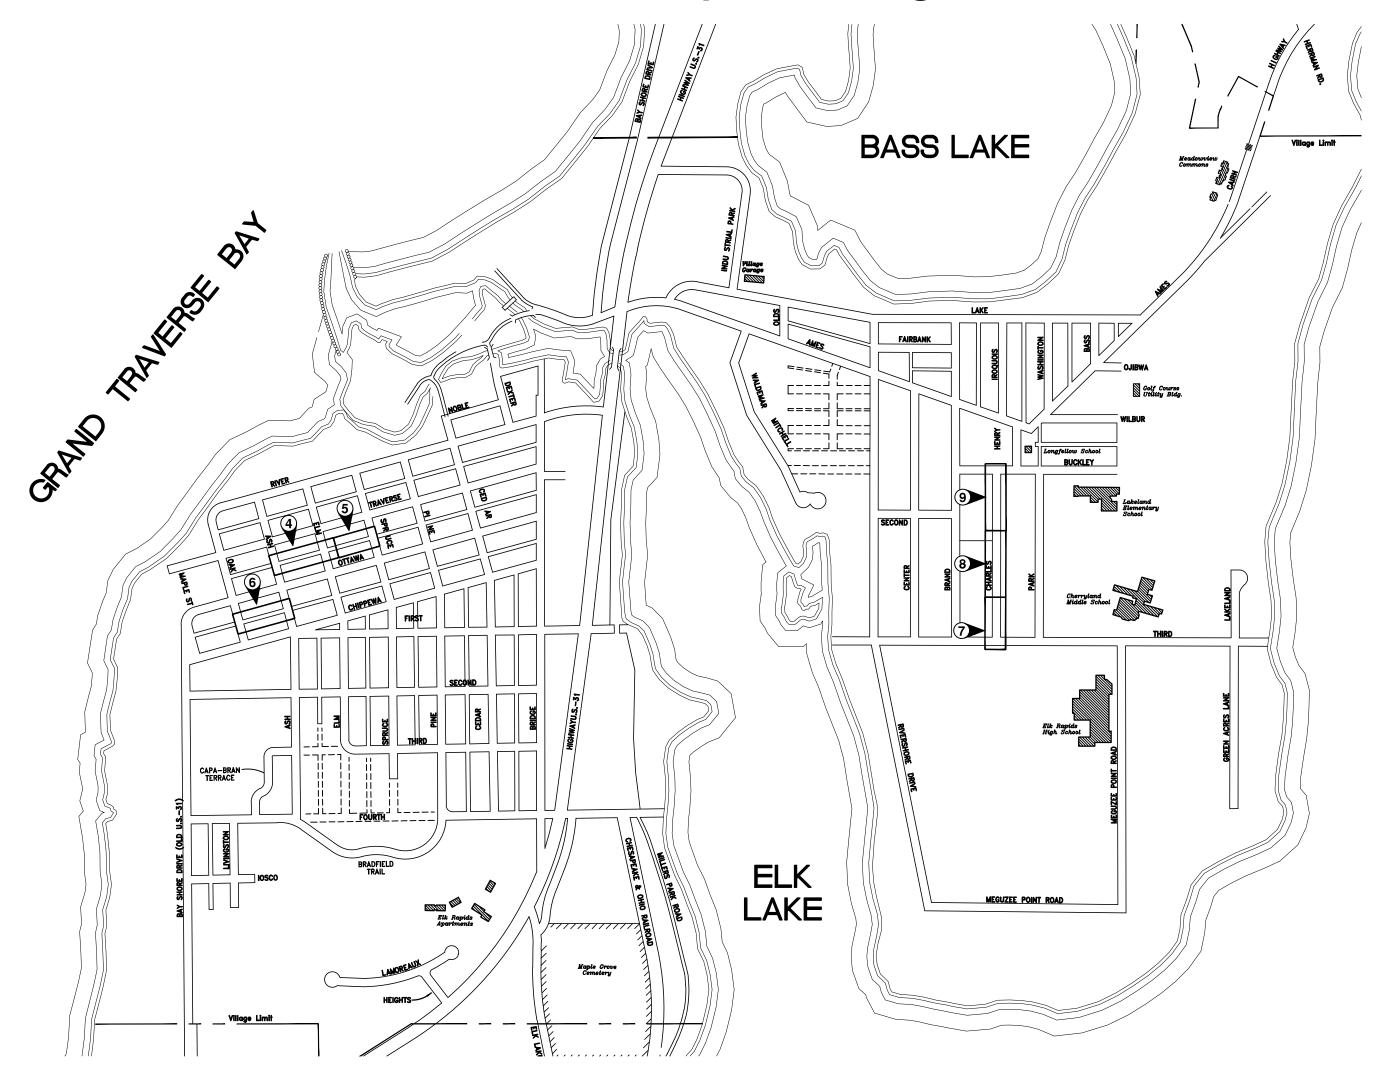

SHEET LIST					
SHEET NUMBER	SHEET TITLE				
1	COVER				
2	GENERAL NOTES				
3	DEMOLITION				
4	STA. 0+00 TO STA. 4+50				
5	STA. 4+50 TO STA. 8+50				
6	STA. 8+50 TO STA. 13+00				
7	STA. 13+00 TO STA. 18+00				
8	STA. 18+00 TO STA. 23+00				
9	STA. 23+00 TO STA. 27+11				
10	DETAILS				

# Village of Elk Rapids **Site Location Map**

SCALE: 1" = 600'

#### **PUBLIC UTILITIES**

THE EXISTING UTILITIES LISTED BELOW AND SHOWN ON THESE PLANS REPRESENT THE BEST INFORMATION AVAILABLE. THIS INFORMATION DOES NOT RELIEVE THE CONTRACTOR OF THE RESPONSIBILITY TO BE SATISFIED AS TO ITS ACCURACY AND THE LOCATION OF EXISTING UTILITIES. THE CONTRACTOR SHALL NOTIFY "MISS DIG" (1-800-482-7171) THREE WORK-ING DAYS PRIOR TO THE START OF CONSTRUCTION.

DTE ENERGY COMPANY
GAS DISTRIBUTION

1294 NORTH U.S. 31 PETOSKEY, MI 49770 231-258-3785 <u>DTE ENERGY COMPANY</u> <u>HIGH PRESSURE GAS TRANSMISSION</u>

> 250 MICHCON LN., KALKASKA, MI 49646 231-499-7648

CHARTER COMMUNICATIONS VILLAGE OF ELK RAPIDS DPW

701 S. AIRPORT RD. 315 BRIDGE STREET TRAVERSE CITY, MI 49686 231-929-7012 EXT. 102 ELK RAPIDS, MI 49629

**CONSUMERS ENERGY** 

821 HASTINGS 142 E. STATE STREET TRAVERSE CITY, MI 49686 TRAVERSE CITY, MI 49684 231-929-6244 231-941-2707

MR. ALEX PRAY

P.O. BOX 398

231-264-9971

<u> AT&T</u>



Know what's below. Call before you dig.

APPROXIMATE ONLY. IT SHALL BE THE RESPONSIBILITY OF THE CONTRACTOR TO VERIFY ACTUAL LOCATION AND DEPTH OF ALL EXISTING UTILITIES. THE OWNER AND THE SURVEYOR SHALL NOT BE RESPONSIBL FOR ANY OMISSION OR VARIATION FROM THE LOCATION SHOWN. THE CONTRACTOR SHALL NOTIFY "MISS DIG" AT 1 (800) 482-7171 OR 811 THREE (3) WORKING DAYS PRIOR TO THE START OF CONSTRUCTION.

ORIGINAL SHEET SIZE IS 22x34 - HALF SCALE SHEET IS 11x1

Gosling C



Issue Date PRELIMINARY Project No. 2023150004

#### PROPOSED FEATURES LEGEND

PROPOSED SANITARY CLEANOUT PROPOSED SANITARY STRUCTURE PROPOSED FORCE MAIN PROPOSED SANITARY LINE PROPOSED SANITARY PUMP STATION PROPOSED WATER LINE PROPOSED WATER HYDRANT PROPOSED WATER SYSTEM VALVE PROPOSED WATER WELL PROPOSED CONCRETE PROPOSED ASPHALT

#### **PLAN NOTES**

- 1. DESIGN SUBJECT TO VERIFICATION OF SITE CONDITIONS.
- 2. PRIOR TO CONSTRUCTION, THE CONTRACTOR SHALL VERIFY ALL PUBLIC AND PRIVATE UTILITY LOCATIONS. CONTRACTOR SHALL ALSO CONTACT "MISS DIG" AT 1-800-482-7171 THREE WORKING DAYS PRIOR TO CONSTRUCTION BEGINNING.
- 3. PRIOR TO CONSTRUCTION, THE CONTRACTOR SHALL FIELD VERIFY ALL PERTINENT VERTICAL CONTROL DATA (I.E. BENCHMARKS, FLOORS, UTILITIES, ETC.)
- 4. INSTALL SILT FENCE AS FIRST STEP BEFORE ANY GRADING ACTIVITIES BEGIN. SEE SESC PLAN. MEASURES SHOWN ON SESC PLAN ARE THE MINIMUM CONTROLS TO BE USED AND THE CONTRACTOR SHALL BE RESPONSIBLE FOR TEMPORARY AND PERMANENT SOIL EROSION CONTROL MEASURES TO PROTECT THE DISTURBED AREAS AND ADJACENT PROPERTIES FROM ACCELERATED EROSION AND SEDIMENTATION RESULTING FROM CONSTRUCTION AT NO ADDITIONAL CHARGE TO THE OWNER. SEE SESC PLAN FOR ADDITIONAL NOTES AND INFORMATION.
- 5. ALL TOPSOIL SHALL BE STRIPPED FROM AREAS TO BE OCCUPIED BY FILL, STRUCTURES, OR IMPROVED SURFACES.
- 6. ALL DISTURBED AREAS SHALL BE TOPSOILED, SEEDED, FERTILIZED, AND MULCHED. MULCH BLANKET SHALL BE INSTALLED IN AREAS WITH SLOPES 1v: 3H AND STEEPER OR AS NEEDED AND SHALL BE INCIDENTAL TO THE WORK.
- 7. ANY AREAS UTILIZED BY CONTRACTOR FOR MATERIAL LAYDOWN SHALL BE RESTORED WITH TOPSOIL, SEED, FERTILIZER, AND MULCH.
- 8. CONTRACTOR SHALL OBTAIN AND COMPLY WITH THE REQUIREMENTS OF SESC PERMIT. CONTRACTOR SHALL COMPLY WITH REQUIREMENTS OFANY OTHER OWNER OBTAINED PERMITS (DRIVEWAY PERMIT, STATE SCHOOLS, ETC.)
- 9. PAVEMENT STRIPING SHALL MEET PROJECT SPECIFICATIONS.

## SITE UTILITY NOTES

- WATER AND SEWER IMPROVEMENTS TO MEET CURRENT LOCAL AND STATE MECHANICAL CODE REQUIREMENTS. MAINTAIN 10 FT OF HORIZONTAL CLEARANCE BETWEEN WATER AND SEWER. PROVIDE SCHEDULE 40 PVC SLEEVE AT ALL LOCATIONS WHERE 10' IS NOT MAINTAINED AND AT ALL CROSSINGS. AT CROSSINGS, PROVIDE 10 FT OF SLEEVE PIPE IN EACH
- 3. CONTRACTOR TO PERFORM ALL CHLORINATION AND DISINFECTION PROCEDURES ON THE NEW WATER SYSTEM TO ALL OUTLET
- 4. CONTRACTOR TO COORDINATE ALL TESTING AND START-UP OF UTILITIES WITH OTHER CONTRACTORS INCLUDING BUT NOT LIMITED TO BUILDING CONTRACTOR.
- 5. SANITARY SEWER GRAVITY PVC SEWER SERVICE PIPE AND FITTINGS:
  - DESIGN STANDARD: ASTM D 3034.
  - WALL THICKNESS: SCHEDULE 40 JOINTS: SOLVENT WELD

### WATER

- MINIMUM COVER ON ALL BURIED WATER LINES, 6'-0" UNLESS OTHERWISE NOTED
- WATER SERVICE LINES SHALL BE PVC C900 FOR PIPING LARGER THAN 3-INCH - WATER SERVICE LINES SHALL BE TYPE K COPPER FOR PIPING 3-INCH AND SMALLER
- WATER VALVES SHALL BE LOCAL MUNICIPAL STANDARD
- CURB BOXES SHALL BE MUELLER IMPROVED EXTENSION TYPE WITH ARCH PATTERN BASE AND OPTIONAL FOOT PIECE OR EQUAL

# **SOIL BORING KEY**

#### STRATA SYMBOLS

POORLY GRADED GRAVEL AND SAND

POORLY GRADED SAND SILTY GRAVEL AND SAND

SILTY SAND

POORLY GRADED CLAYEY SILTY SAND

#### SOIL EROSION & SEDIMENTATION CONTROL NOTES

- 1. ALL WORK SHALL COMPLY WITH THE APPLICABLE SOIL EROSION AND SEDIMENTATION CONTROL (SESC) RULES AND REGULATIONS (SOIL EROSION AND SEDIMENTATION CONTROL -1994 PA 451. PART 91. AS AMENDED. MCL 324.9101 ET SEQ.).
- 2. SOIL EROSION AND SEDIMENTATION CONTROL SHALL PROTECT AGAINST LOSS OF SOIL BY THE ACTION OF WATER, ICE, AND WIND.
- 3. THE CONTRACTOR IS REQUIRED TO FOLLOW THE CONDITIONS OUTLINED IN THE SOIL EROSION AND SEDIMENTATION CONTROL PERMIT.
- 4. THE CONTRACTOR SHALL IMPLEMENT SOIL EROSION AND SEDIMENTATION CONTROL MEASURES AS REQUIRED BY THE PROJECT'S SESC PLAN, LEELANAU COUNTY PERMIT REQUIREMENTS, DTMB'S SOIL EROSION AND SEDIMENTATION CONTROL GUIDEBOOK, DATED FEBRUARY 2005, AND AS DIRECTED BY THE ENGINEER.
- 5. BASIC PRINCIPLES OF THE SOIL EROSION AND SEDIMENTATION CONTROL PLAN ARE AS
- KEEP DISTURBED AREA AS SMALL AS POSSIBLE
- STABILIZE AND/OR PROTECT DISTURBED AREAS AS SOON
- AS POSSIBLE. KEEP STORM WATER RUNOFF VELOCITIES LOW.
- RETAIN SEDIMENT WITHIN IMMEDIATE CONSTRUCTION AREA.
- 6. THE CONTRACTOR SHALL INSTALL TEMPORARY EROSION AND SEDIMENTATION CONTROL MEASURES PRIOR TO OR UPON COMMENCEMENT TO EARTHWORK ACTIVITIES.
- 7. THE CONTRACTOR WILL PERFORM SWEEPING AS NEEDED TO REMOVE ANY SEDIMENT DIRT AND MUD TRACKED ONTO PUBLIC ROADS SHALL BE REMOVED DAILY. SCRAPE DAILY OR AS NEEDED. SWEEP ROADS ONCE A WEEK. ROADS SHALL ALSO BE CLEANED IMMEDIATELY AFTER A RAIN EVENT.
- 9. DISTURBED AREAS THAT WILL REMAIN IDLE DURING CONSTRUCTION MUST BE TEMPORARILY STABILIZED, INCLUDING SOIL STOCKPILES, USING DTMB SESC BEST MANAGEMENT PRACTICES.
- 10. ALL DISTURBED SURFACE AREAS (INCLUDING UTILITY TRENCHES) SHALL BE TEMPORARILY GRADED AND/OR DITCHED TO DIRECT WATER RUNOFF FROM SUCH AREAS TO SEDIMENTATION CONTROL DEVICES WHICH WILL PREVENT DISTURBING ERODED WATER

CARRYING SOIL FROM ENTERING A WATERCOURSE, SEWER, OR ADJACENT LANDS. SUCH SEDIMENTATION CONTROL DEVICES SHALL INCLUDE BUT NOT BE LIMITED TO PROTECTIVE DITCHES, SEDIMENT TRAPS, SEDIMENT FILTERS, DITCH TRAPS, PIPE BARRIERS, STRAW BALE BERMS AND FILTERS AS DETAILED AND REQUIRED AND LOCATED ON THE DRAWINGS. AFTER THE PROJECT WORK HAS BEEN COMPLETED. INSPECTED AND APPROVED. THE CONTRACTOR SHALL REMOVE ALL SEDIMENTATION CONTROL DEVICES, MATERIAL AND THEIR COLLECTED SILT AND DEBRIS AND COMPLETE THE PROJECT WORK IN ACCORDANCE WITH THE DRAWINGS AND SPECIFICATIONS.

- 11. THE CONTRACTOR SHALL MAINTAIN AND INSPECT SESC MEASURES THROUGHOUT THE COURSE OF THE PROJECT. RECOMMEND INSPECTING AND MAINTAINING EROSION AND SEDIMENTATION CONTROLS ON A DAILY BASIS. AT A MINIMUM, THE CONTRACTOR SHALL INSPECT AND MAINTAIN SESC MEASURES ONCE A WEEK AND AFTER RAIN EVENTS. COLLECTED SILT AND SEDIMENTATION SHALL BE REMOVED AS REQUIRED TO MAINTAIN THE EFFECTIVENESS OF THE SILT TRAPS OR SEDIMENTATION CONTROL DEVICES. IN SILT FENCE APPLICATIONS SEDIMENT SHALL BE REMOVED WHEN THE HEIGHT REACHES ONE HALF THE HEIGHT OF THE FABRIC. WHERE REQUIRED, THE CONTRACTOR SHALL REPLACE FILTER MATERIALS WHICH HAVE BECOME INEFFECTIVE DUE TO CONTAMINATION OR PHYSICAL DETERIORATION. THE CONTRACTOR SHALL INSPECT ALL SOIL AND EROSION AND SEDIMENTATION CONTROL DEVICES AFTER ALL STORM EVENTS.
- 12. THE CONTRACTOR SHALL CORRECT NON-CONFORMING SESC MEASURES WITHIN 24 HOURS. IF WATERS OF THE STATE ARE BEING IMPACTED OR WITHIN 48 HOURS FOR ROUTINE MAINTENANCE ITEMS. OTHER SESC MAINTENANCE SHALL BE COMPLETED AS SOON AS POSSIBLE BUT NEVER MORE THAN FIVE (5) DAYS AFTER DETECTION.
- 13. THE CONTRACTOR SHALL COMPLETE PERMANENT SOIL EROSION CONTROL MEASURES FOR TRACKED OFF SITE. FREQUENCY OF SWEEPING WILL BE BASED ON SITE CONDITIONS. ALL ANY DISTURBED LAND AREA WITHIN 5 CALENDAR DAYS AFTER FINAL GRADING OR THE FINAL EARTH CHANGE HAS BEEN COMPLETED. THE CONTRACTOR SHALL MAINTAIN TEMPORARY CONTROL MEASURES UNTIL PERMANENT SOILL EROSION CONTROL MEASURES ARE IN PLACE AND THE AREA IS STABILIZED.
- 8. THE CONTRACTOR WILL PERFORM DUST CONTROL AS NEEDED BASED ON SITE CONDITIONS. 14. THE CONTRACTOR SHALL REMOVE TEMPORARY EROSION CONTROL MEASURES AFTER PERMANENT SOIL EROSION MEASURES ARE IN PLACE AND THE AREA IS STABILIZED. CARE SHALL BE TAKEN DURING REMOVAL TO PREVENT SOIL EROSION AND SEDIMENTATION.
  - 15. AFTER THE COMPLETION OF THE PROJECT, PERMANENT SESC MEASURES WILL BE MAINTAINED BY THE PROPERTY OWNER.

### DTMB SESC KEY LEGEND

	BTINIB GEGG RET EEGENB					
E5	DUST CONTROL		For use on construction sites, unpaved roads, etc. to reduce dust and sedimentation from wind and construction activities.			
E6	MULCH		On flat areas, mild slopes, grassed waterways and spillways, diversion ditches and dikes, borrow and stockpile areas, and spoil piles when areas are subject to raindrop impact, and erosive forces from wind or water.			
E9	MULCH BLANKETS		On exposed slopes, newly seeded areas, new ditch bottoms, or areas subject to erosion.			
E8	PERMANENT SEEDING	AND THE REAL PROPERTY OF THE PARTY OF THE PA	Stabilization method utilized on sites where earth change has been completed (final grading attained).			
S51	SILT FENCE		Use adjacent to critical areas, to prevent sediment laden sheet flow from entering these areas.			

DENOTES PERMANENT MEASURE



WATERBODY STATEMENT:

NEAREST WATERBODY APPEARS TO BE BOW LAKE, LOCATED ±4,200 FEET EAST OF THE PROJECT AREA


Call before you dig.

THE LOCATION OF THE EXISTING UTILITIES, AS SHOWN ON THIS PLAN, ARE APPROXIMATE ONLY. IT SHALL BE THE RESPONSIBILITY OF THE CONTRACTOR TO VERIFY ACTUAL LOCATION AND DEPTH OF ALL EXISTING UTILITIES. THE OWNER AND THE SURVEYOR SHALL NOT BE RESPONSIBLE FOR ANY OMISSION OR VARIATION FROM THE LOCATION SHOWN. THE CONTRACTOR SHALL NOTIFY "MISS DIG" AT 1 (800) 482-7171 OR 811 THREE (3) WORKING DAYS PRIOR TO THE START OF CONSTRUCTION.

iosling Gzuba engineering sciences, in

1280 Business Park Dr Traverse City, Michigar 231-946-9191 phone info@goslingczubak.com www.goslingczubak.com

CIVIL ENGINEERING SURVEYING **ENVIRONMENTAL SERVICES** GEOTECHNICAL CONSTRUCTION SERVICES DRILLING LANDSCAPE ARCHITECTURE

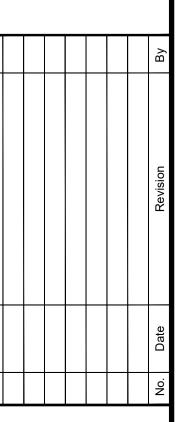


NOTES: VARIOU RAI ACI OF I S


PRELIMINAF Date Surveyed: Designed By: Orawn By: Checked By: AS NOTED


> Original sheet size is 22x34 T29N R09W S21


VILLAGE OF ELK RAPIDS ANTRIM COUNTY MICHIGAN

Project Number: 2023150004

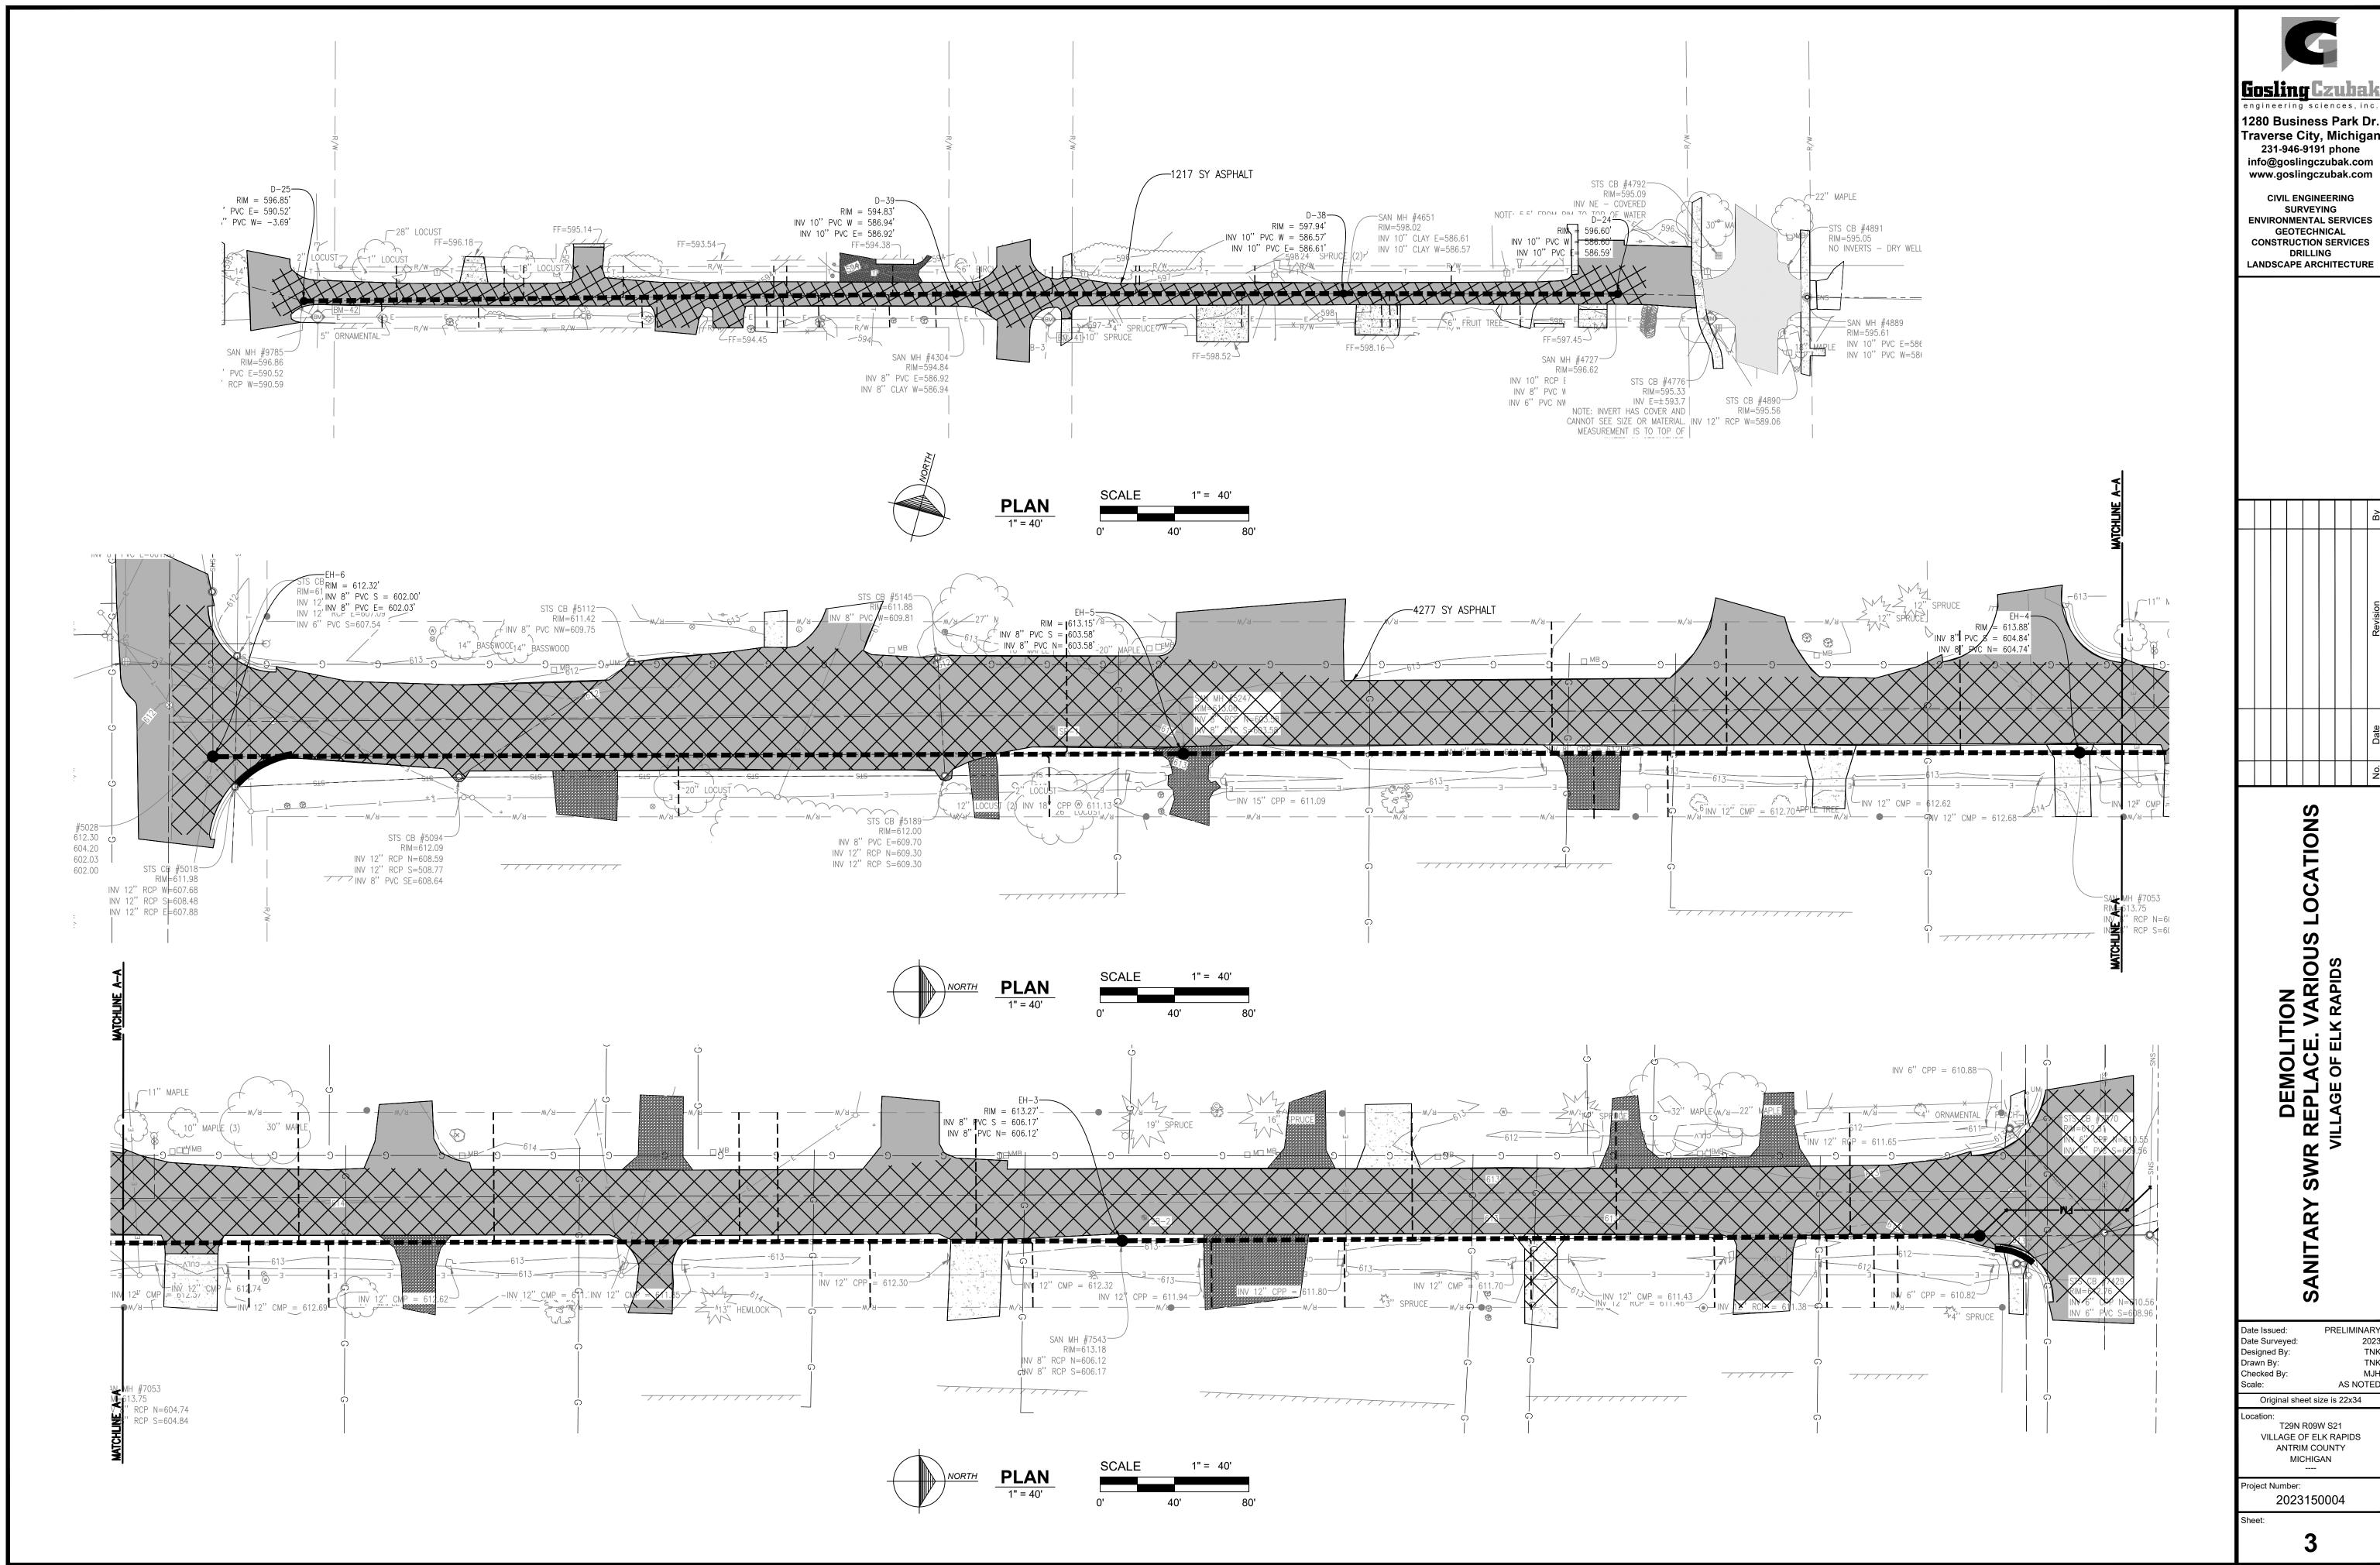

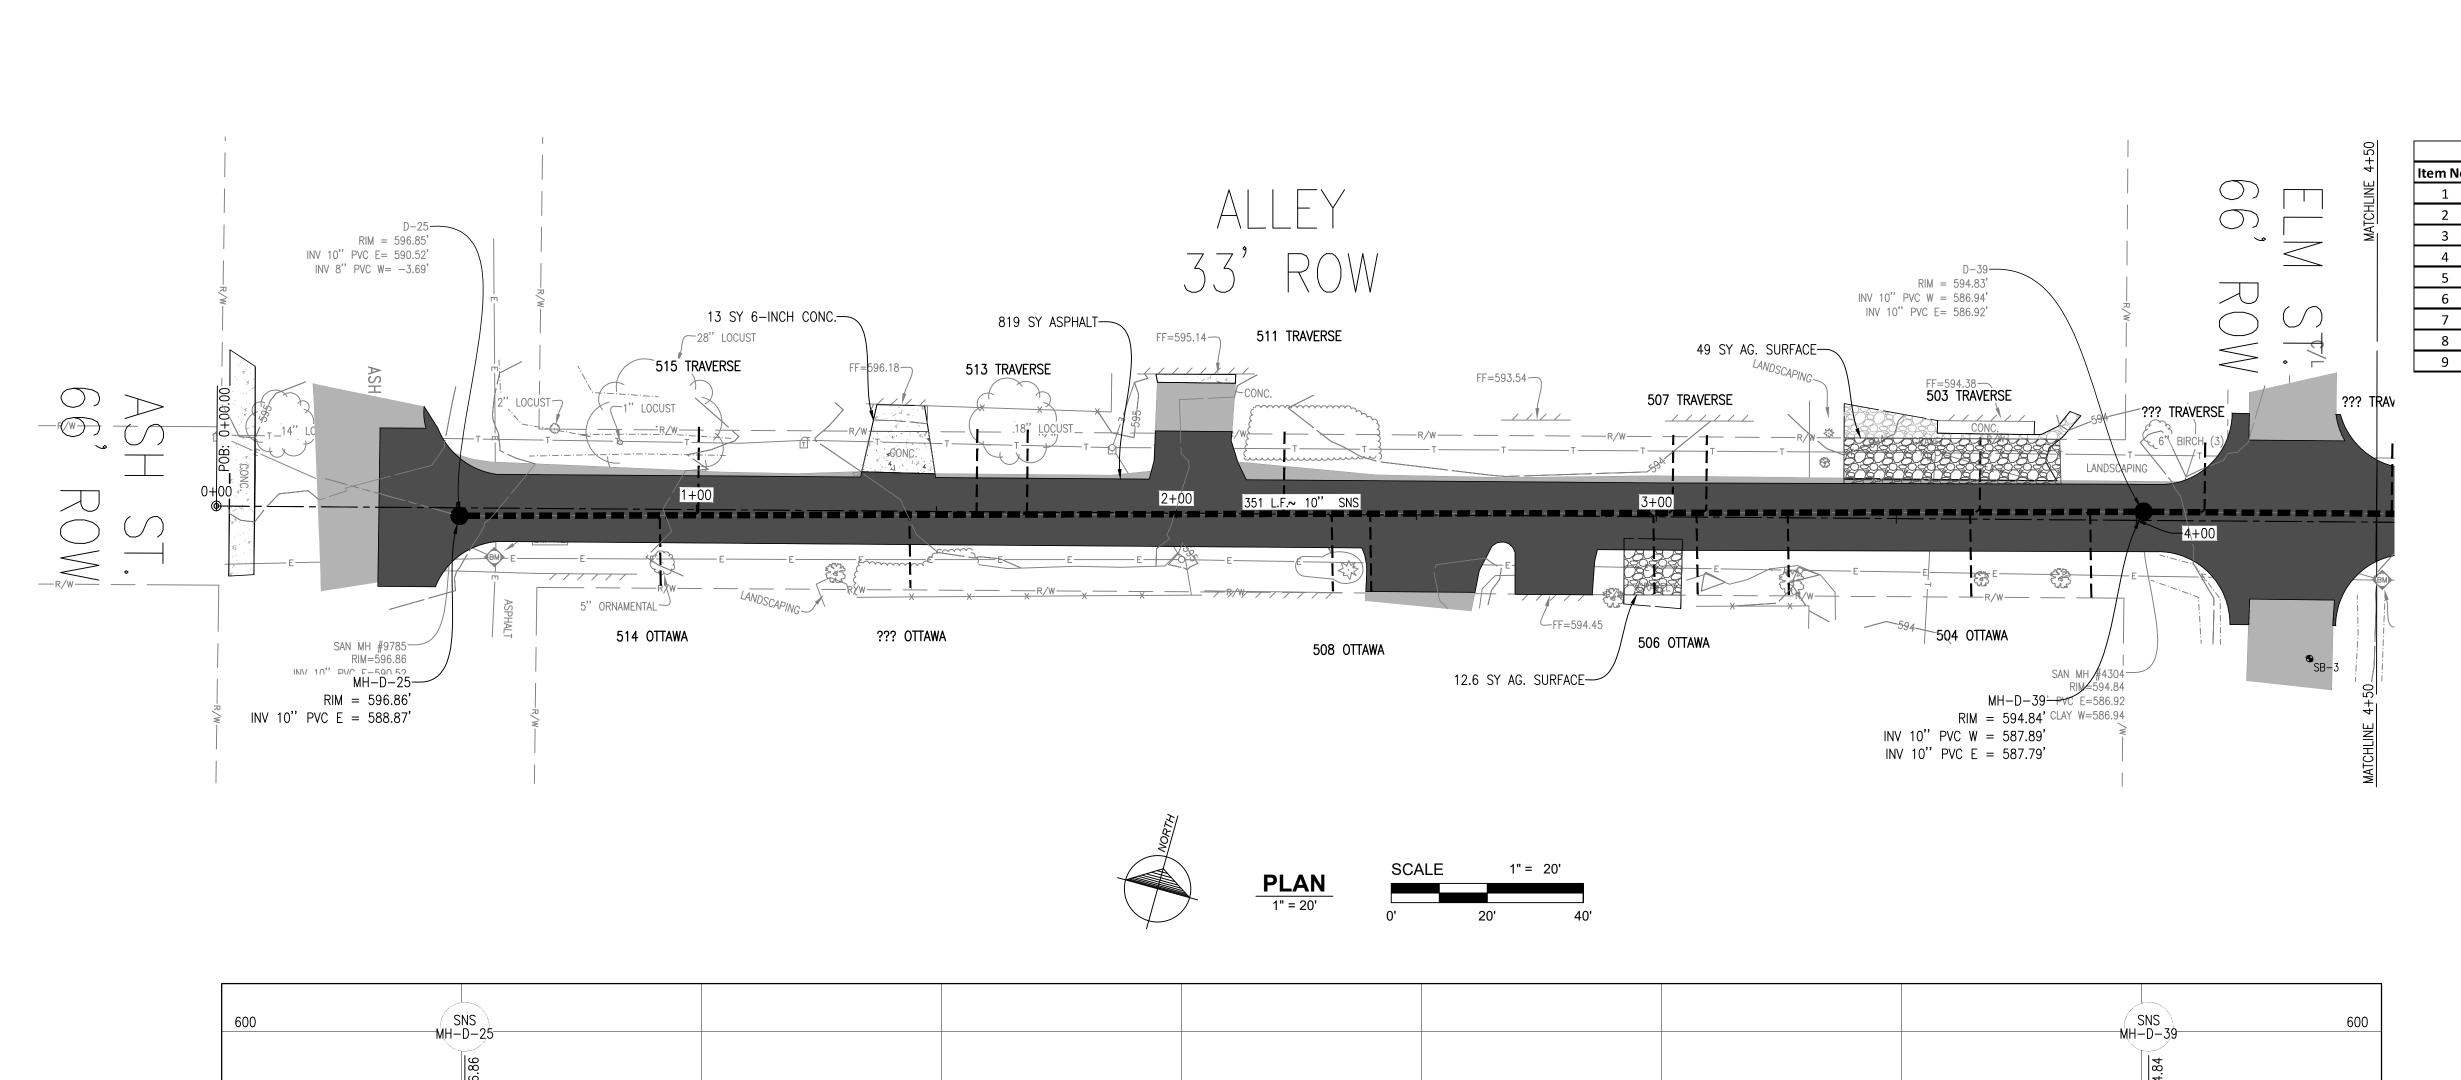

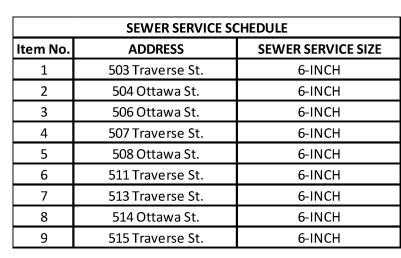

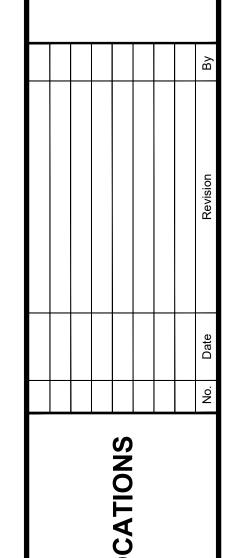

1280 Business Park Dr.

Traverse City, Michigan 231-946-9191 phone


info@goslingczubak.com www.goslingczubak.com

CIVIL ENGINEERING SURVEYING

ENVIRONMENTAL SERVICES GEOTECHNICAL

CONSTRUCTION SERVICES DRILLING

LANDSCAPE ARCHITECTURE

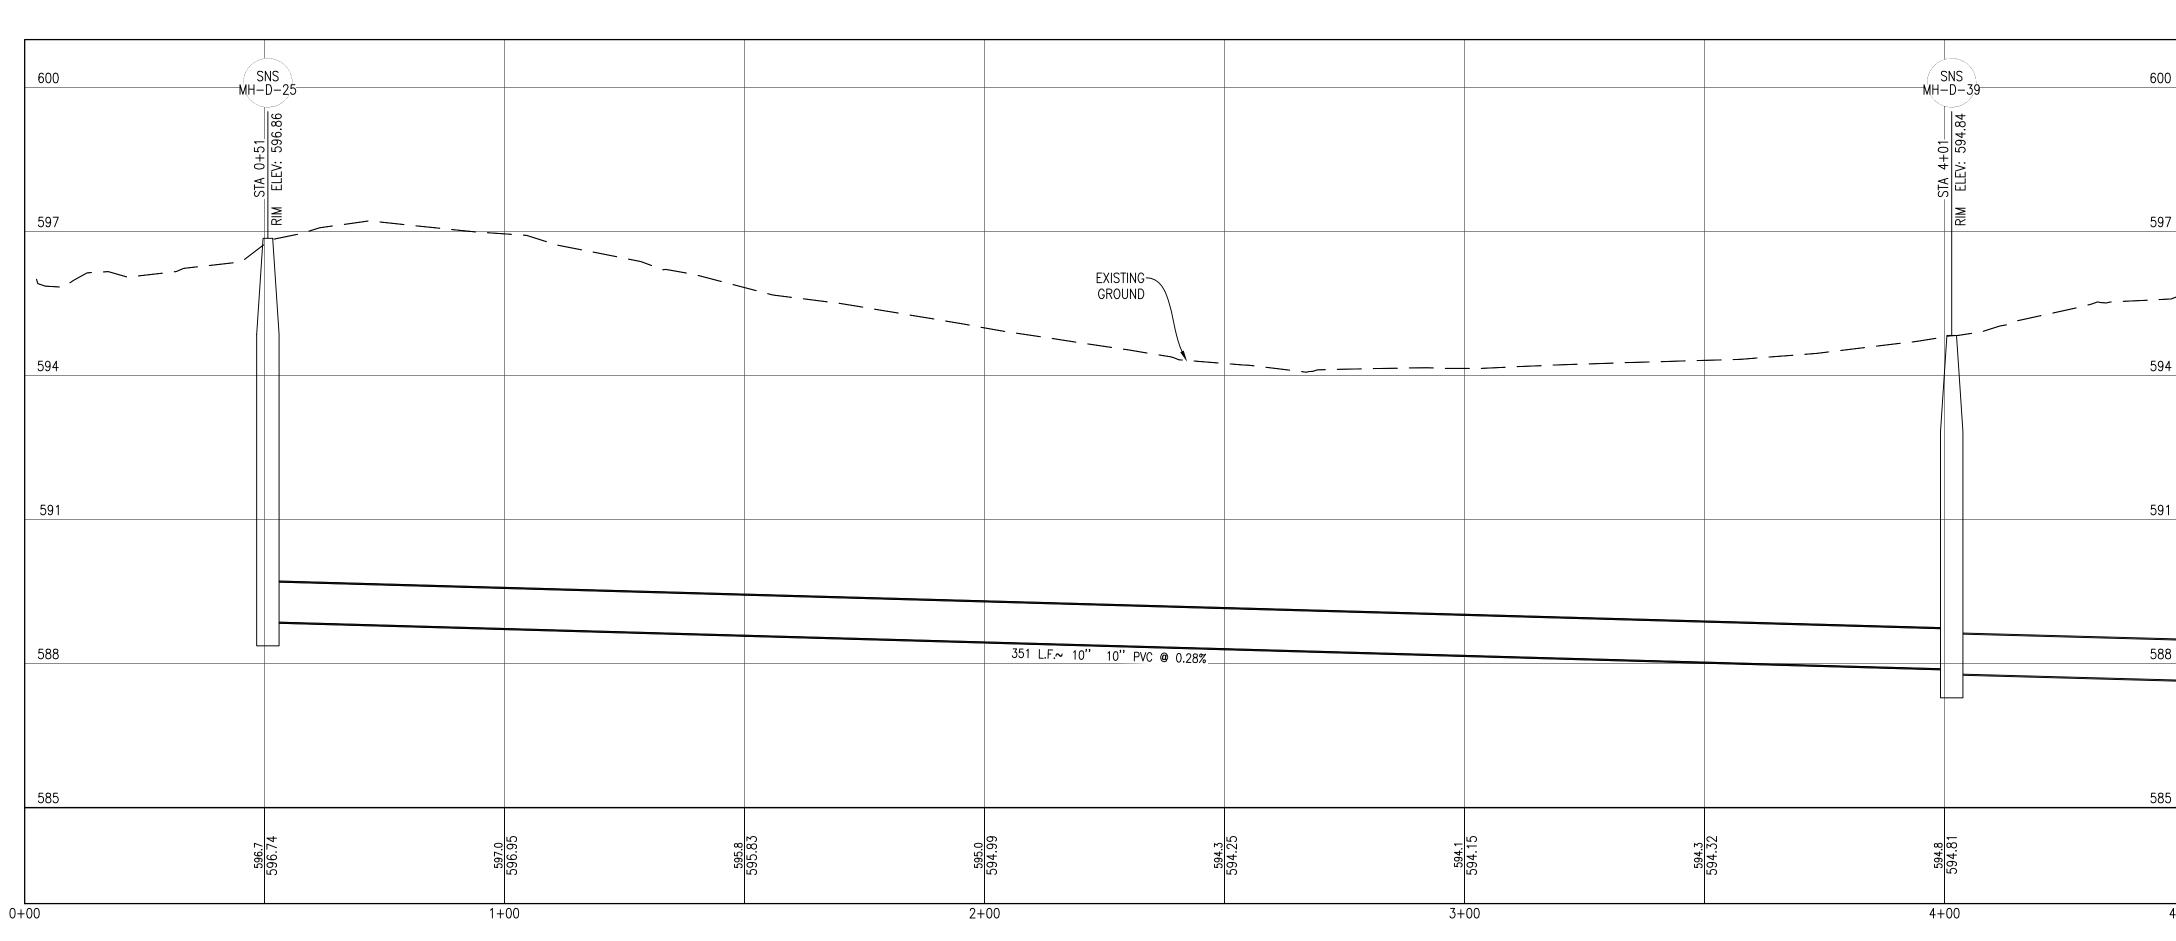

Know what's below.

4+50

Call before you dig.


THE LOCATION OF THE EXISTING UTILITIES, AS SHOWN ON THIS PLAN, ARE APPROXIMATE ONLY. IT SHALL BE THE RESPONSIBILITY OF THE CONTRACTOR TO VERIFY ACTUAL LOCATION AND DEPTH OF ALL EXISTING UTILITIES. THE OWNER AND THE SURVEYOR SHALL NOT BE RESPONSIBLE FOR ANY OMISSION OR VARIATION FROM THE LOCATION SHOWN. THE CONTRACTOR SHALL NOTIFY "MISS DIG" AT 1 (800) 482-7171 OR 811 THREE (3) WORKING DAYS PRIOR TO THE START OF CONSTRUCTION.


Date Issued:	PRELIMI		
Date Surveyed:			
Designed By:			
Drawn By:			
Checked By:			
Scale:	AS NO		
Original sheet size is 22x34			
Location:			
T29N F	R09W S21		
VILLAGE O	F ELK RAPIDS		
 4417014			

ANTRIM COUNTY MICHIGAN

2023150004

**PROFILE** HORIZONTAL SCALE: 1" = 20' VERTICAL SCALE: 1" = 2'

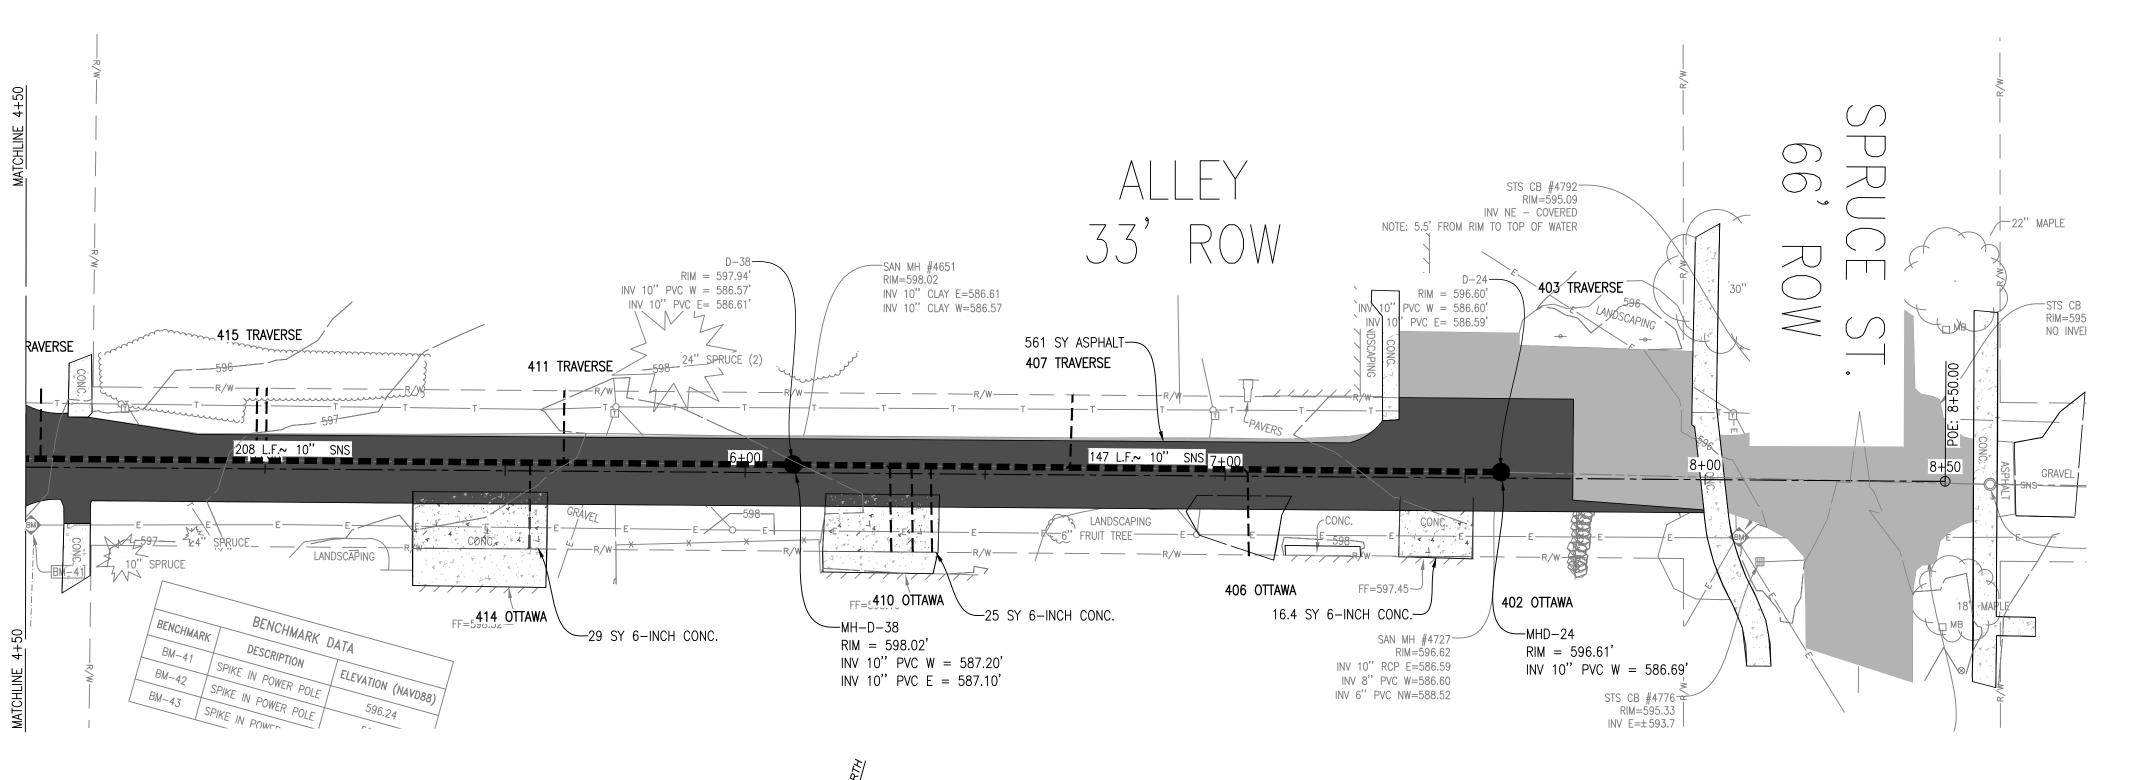

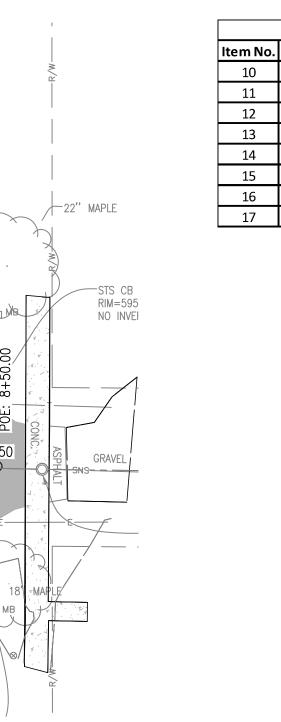

SEWER SERVICE SCHEDULE

**SEWER SERVICE SIZE** 

6-INCH

6-INCH

6-INCH

6-INCH

6-INCH

6-INCH

6-INCH

6-INCH

**ADDRESS** 

402 Ottawa St.

403 Traverse St.

406 Ottawa St.


407 Traverse St.

410 Ottawa St.

411 Traverse St.

414 Ottawa St.

415 Traverse St.

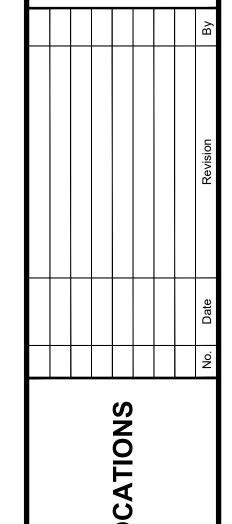

Gosling Czubal

engineering sciences, inc

1280 Business Park Dr. Traverse City, Michigan

231-946-9191 phone

info@goslingczubak.com

www.goslingczubak.com

CIVIL ENGINEERING

SURVEYING

**ENVIRONMENTAL SERVICES** 

GEOTECHNICAL CONSTRUCTION SERVICES DRILLING

LANDSCAPE ARCHITECTURE

Date Issued: Date Surveyed: Designed By: Know what's below.

Call before you dig. Drawn By: Checked By: Original sheet size is 22x34

UTILITIES. THE OWNER AND THE SURVEYOR SHALL NOT BE RESPONSIBLE FOR ANY OMISSION OR VARIATION FROM THE LOCATION SHOWN. THE

CONTRACTOR SHALL NOTIFY "MISS DIG" AT 1 (800) 482-7171 OR 811

THREE (3) WORKING DAYS PRIOR TO THE START OF CONSTRUCTION.


THE LOCATION OF THE EXISTING UTILITIES, AS SHOWN ON THIS PLAN, ARE APPROXIMATE ONLY. IT SHALL BE THE RESPONSIBILITY OF THE CONTRACTOR TO VERIFY ACTUAL LOCATION AND DEPTH OF ALL EXISTING

T29N R09W S21 VILLAGE OF ELK RAPIDS ANTRIM COUNTY MICHIGAN


PRELIMINARY

Project Number: 2023150004


5

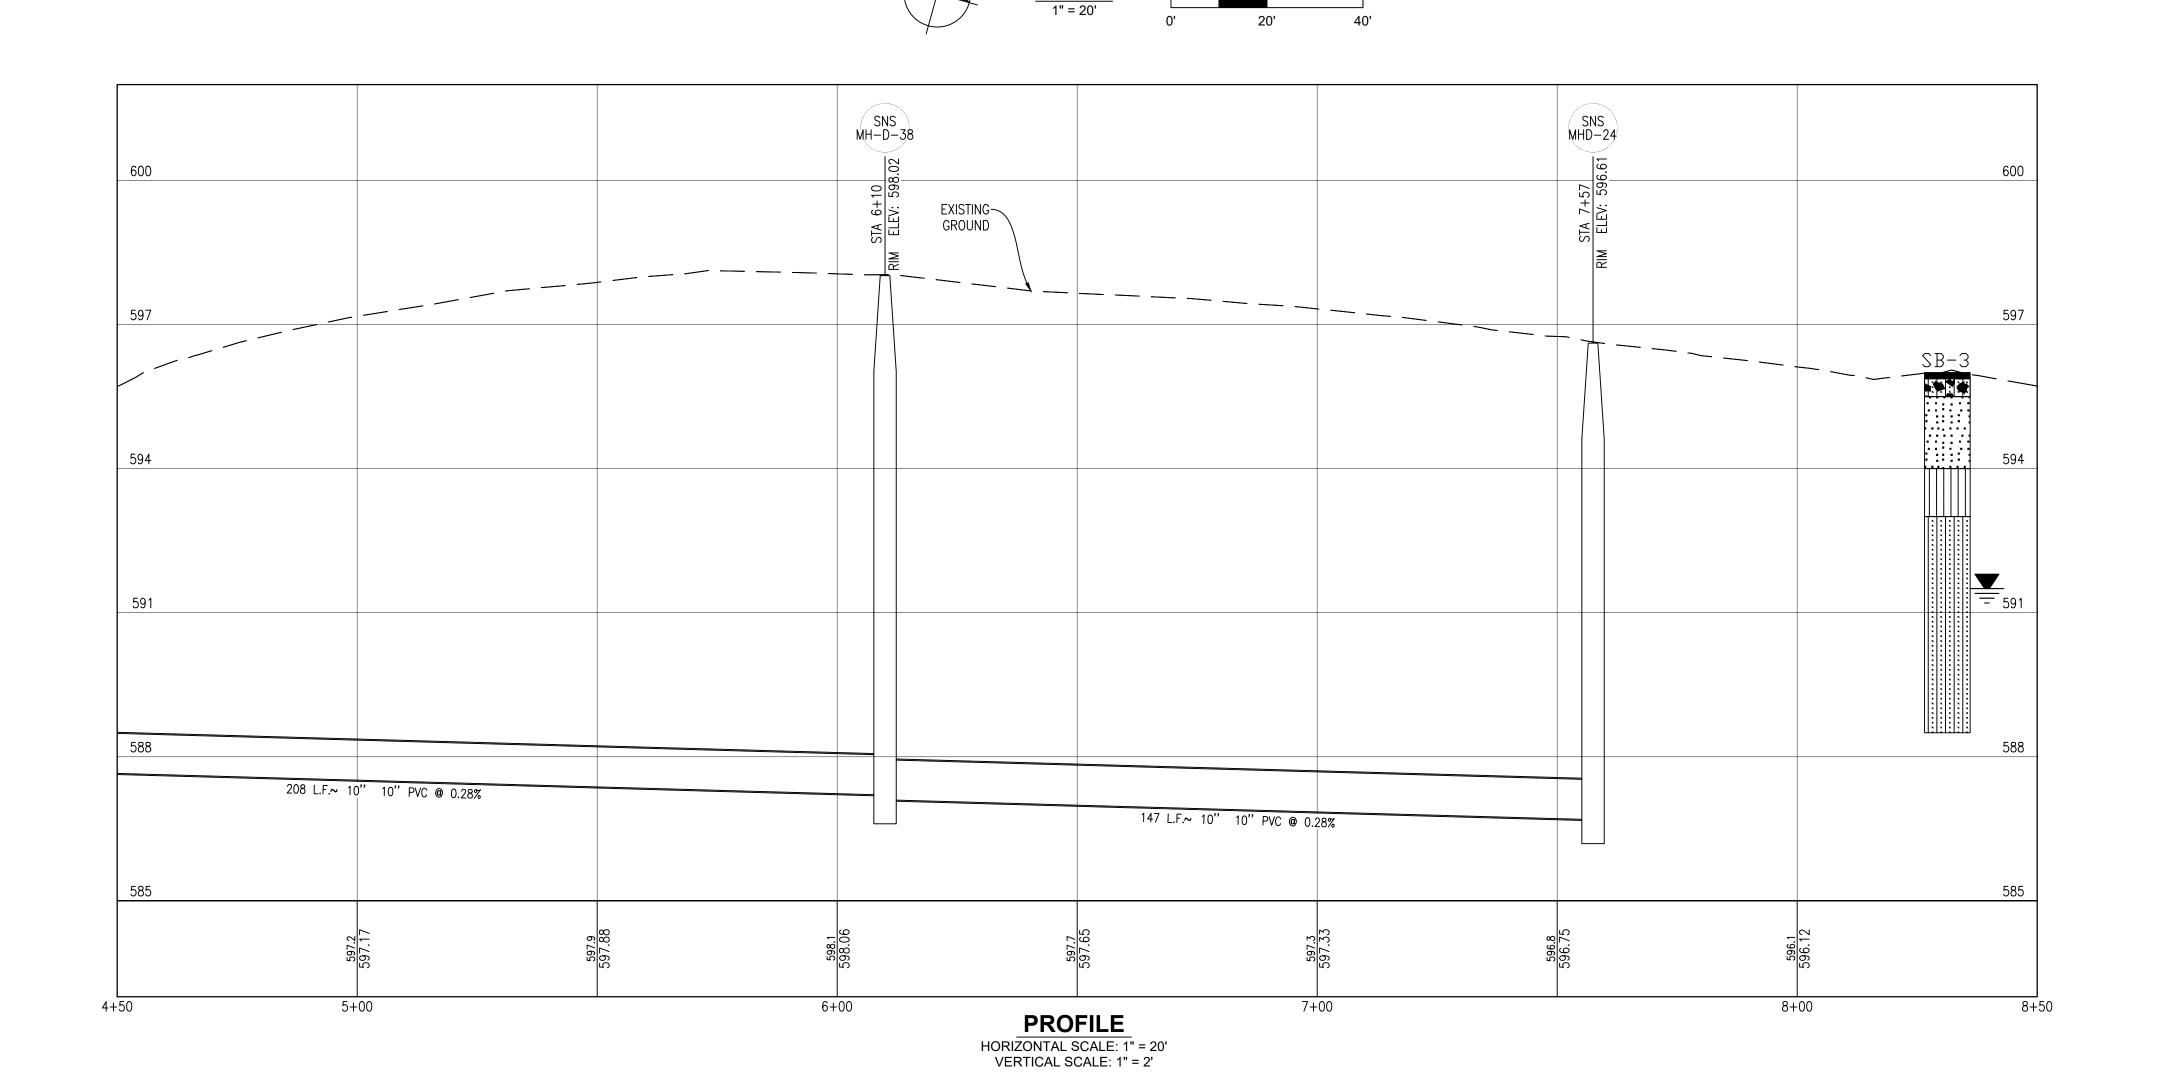

**PLAN** 

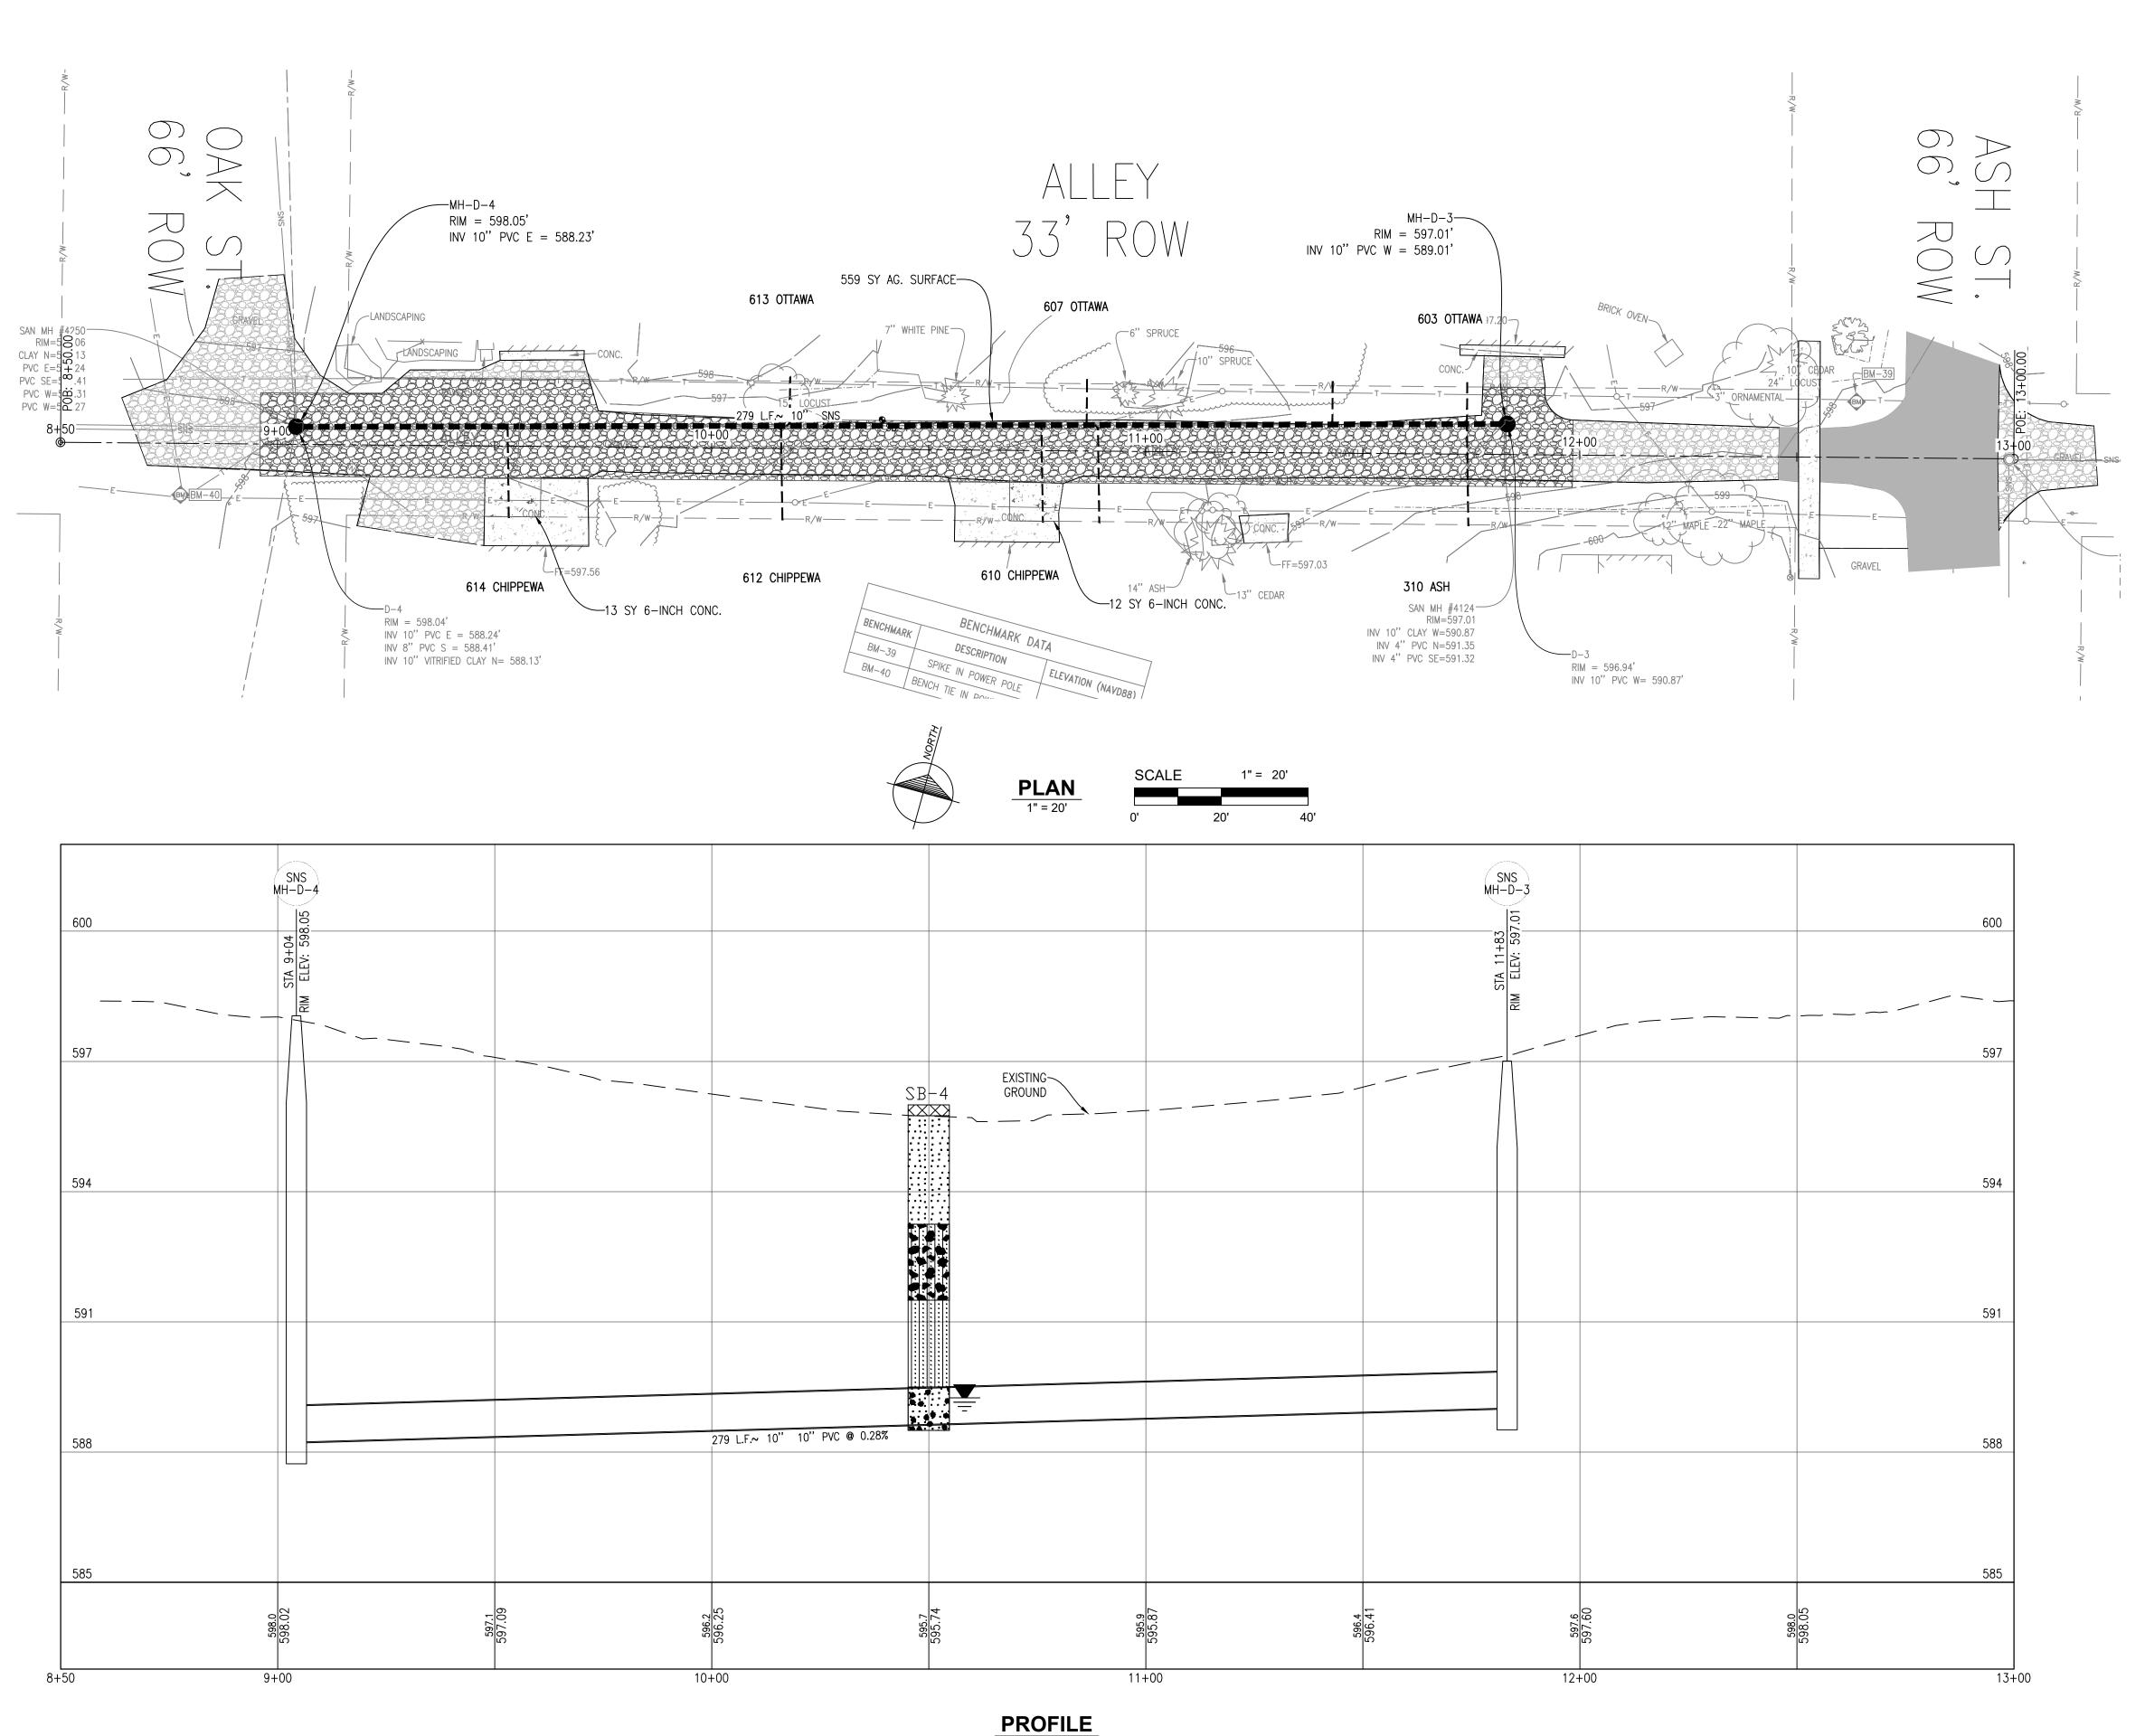

HORIZONTAL SCALE: 1" = 20' VERTICAL SCALE: 1" = 2'

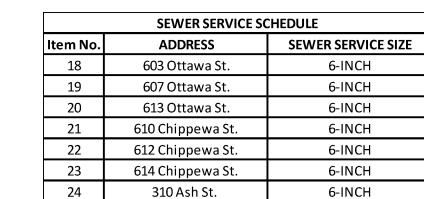

<u>Gosling Czubal</u>

1280 Business Park Dr.

Traverse City, Michigan

231-946-9191 phone

info@goslingczubak.com www.goslingczubak.com


CIVIL ENGINEERING

SURVEYING

**ENVIRONMENTAL SERVICES** 

GEOTECHNICAL
CONSTRUCTION SERVICES
DRILLING

LANDSCAPE ARCHITECTURE

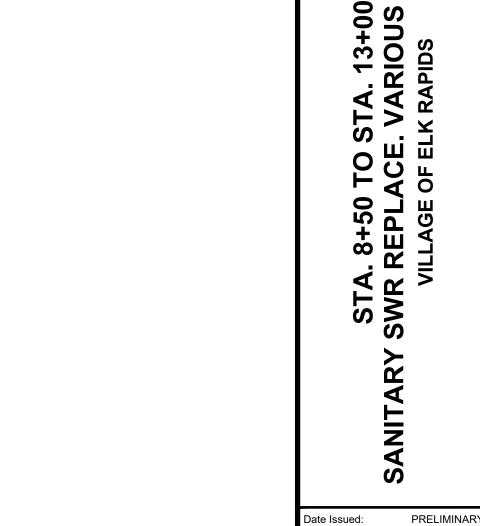

Know what's below.
Call before you dig.

Date Issued:
Date Surveyed:
Designed By:
Drawn By:
Checked By:
Scale:
Original she

THE LOCATION OF THE EXISTING UTILITIES, AS SHOWN ON THIS PLAN, ARE APPROXIMATE ONLY. IT SHALL BE THE RESPONSIBILITY OF THE CONTRACTOR TO VERIFY ACTUAL LOCATION AND DEPTH OF ALL EXISTING UTILITIES. THE OWNER AND THE SURVEYOR SHALL NOT BE RESPONSIBLE FOR ANY OMISSION OR VARIATION FROM THE LOCATION SHOWN. THE CONTRACTOR SHALL NOTIFY "MISS DIG" AT 1 (800) 482-7171 OR 811 THREE (3) WORKING DAYS PRIOR TO THE START OF CONSTRUCTION.


Original sheet size is 22x34


Location:
T29N R09W S21
VILLAGE OF ELK RAPIDS
ANTRIM COUNTY
MICHIGAN
----


AS NOTED

Project Number: 2023150004


6

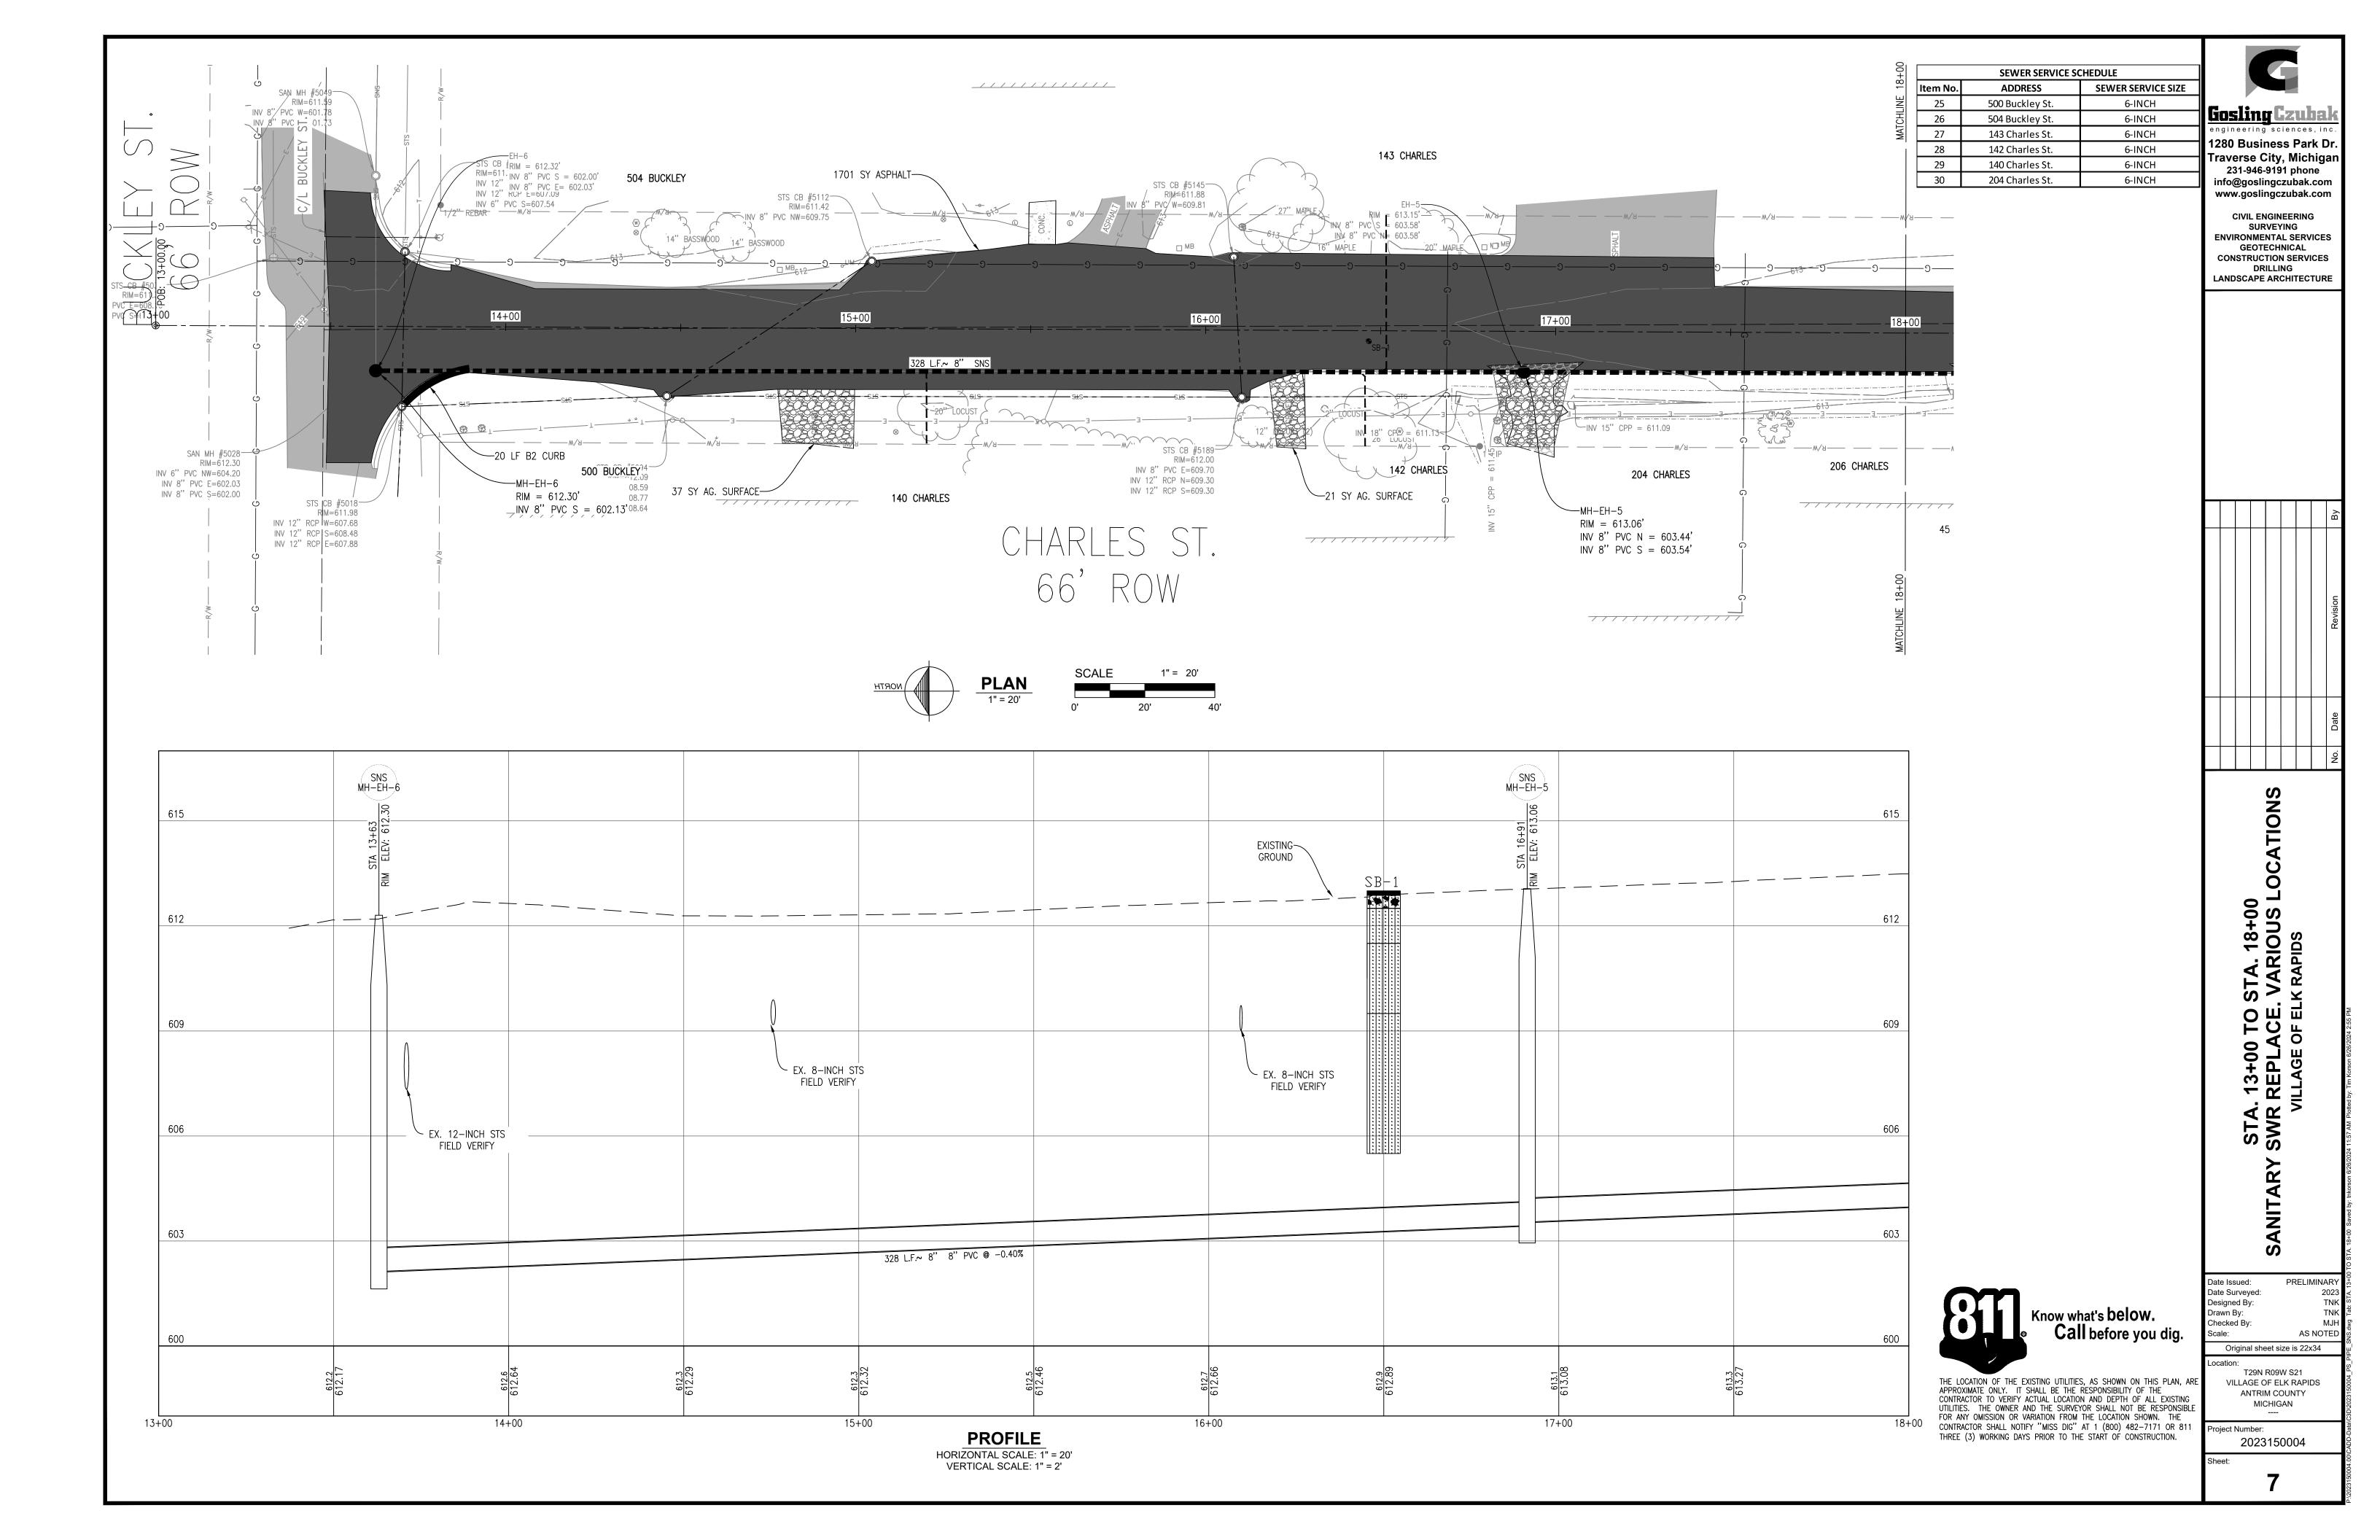

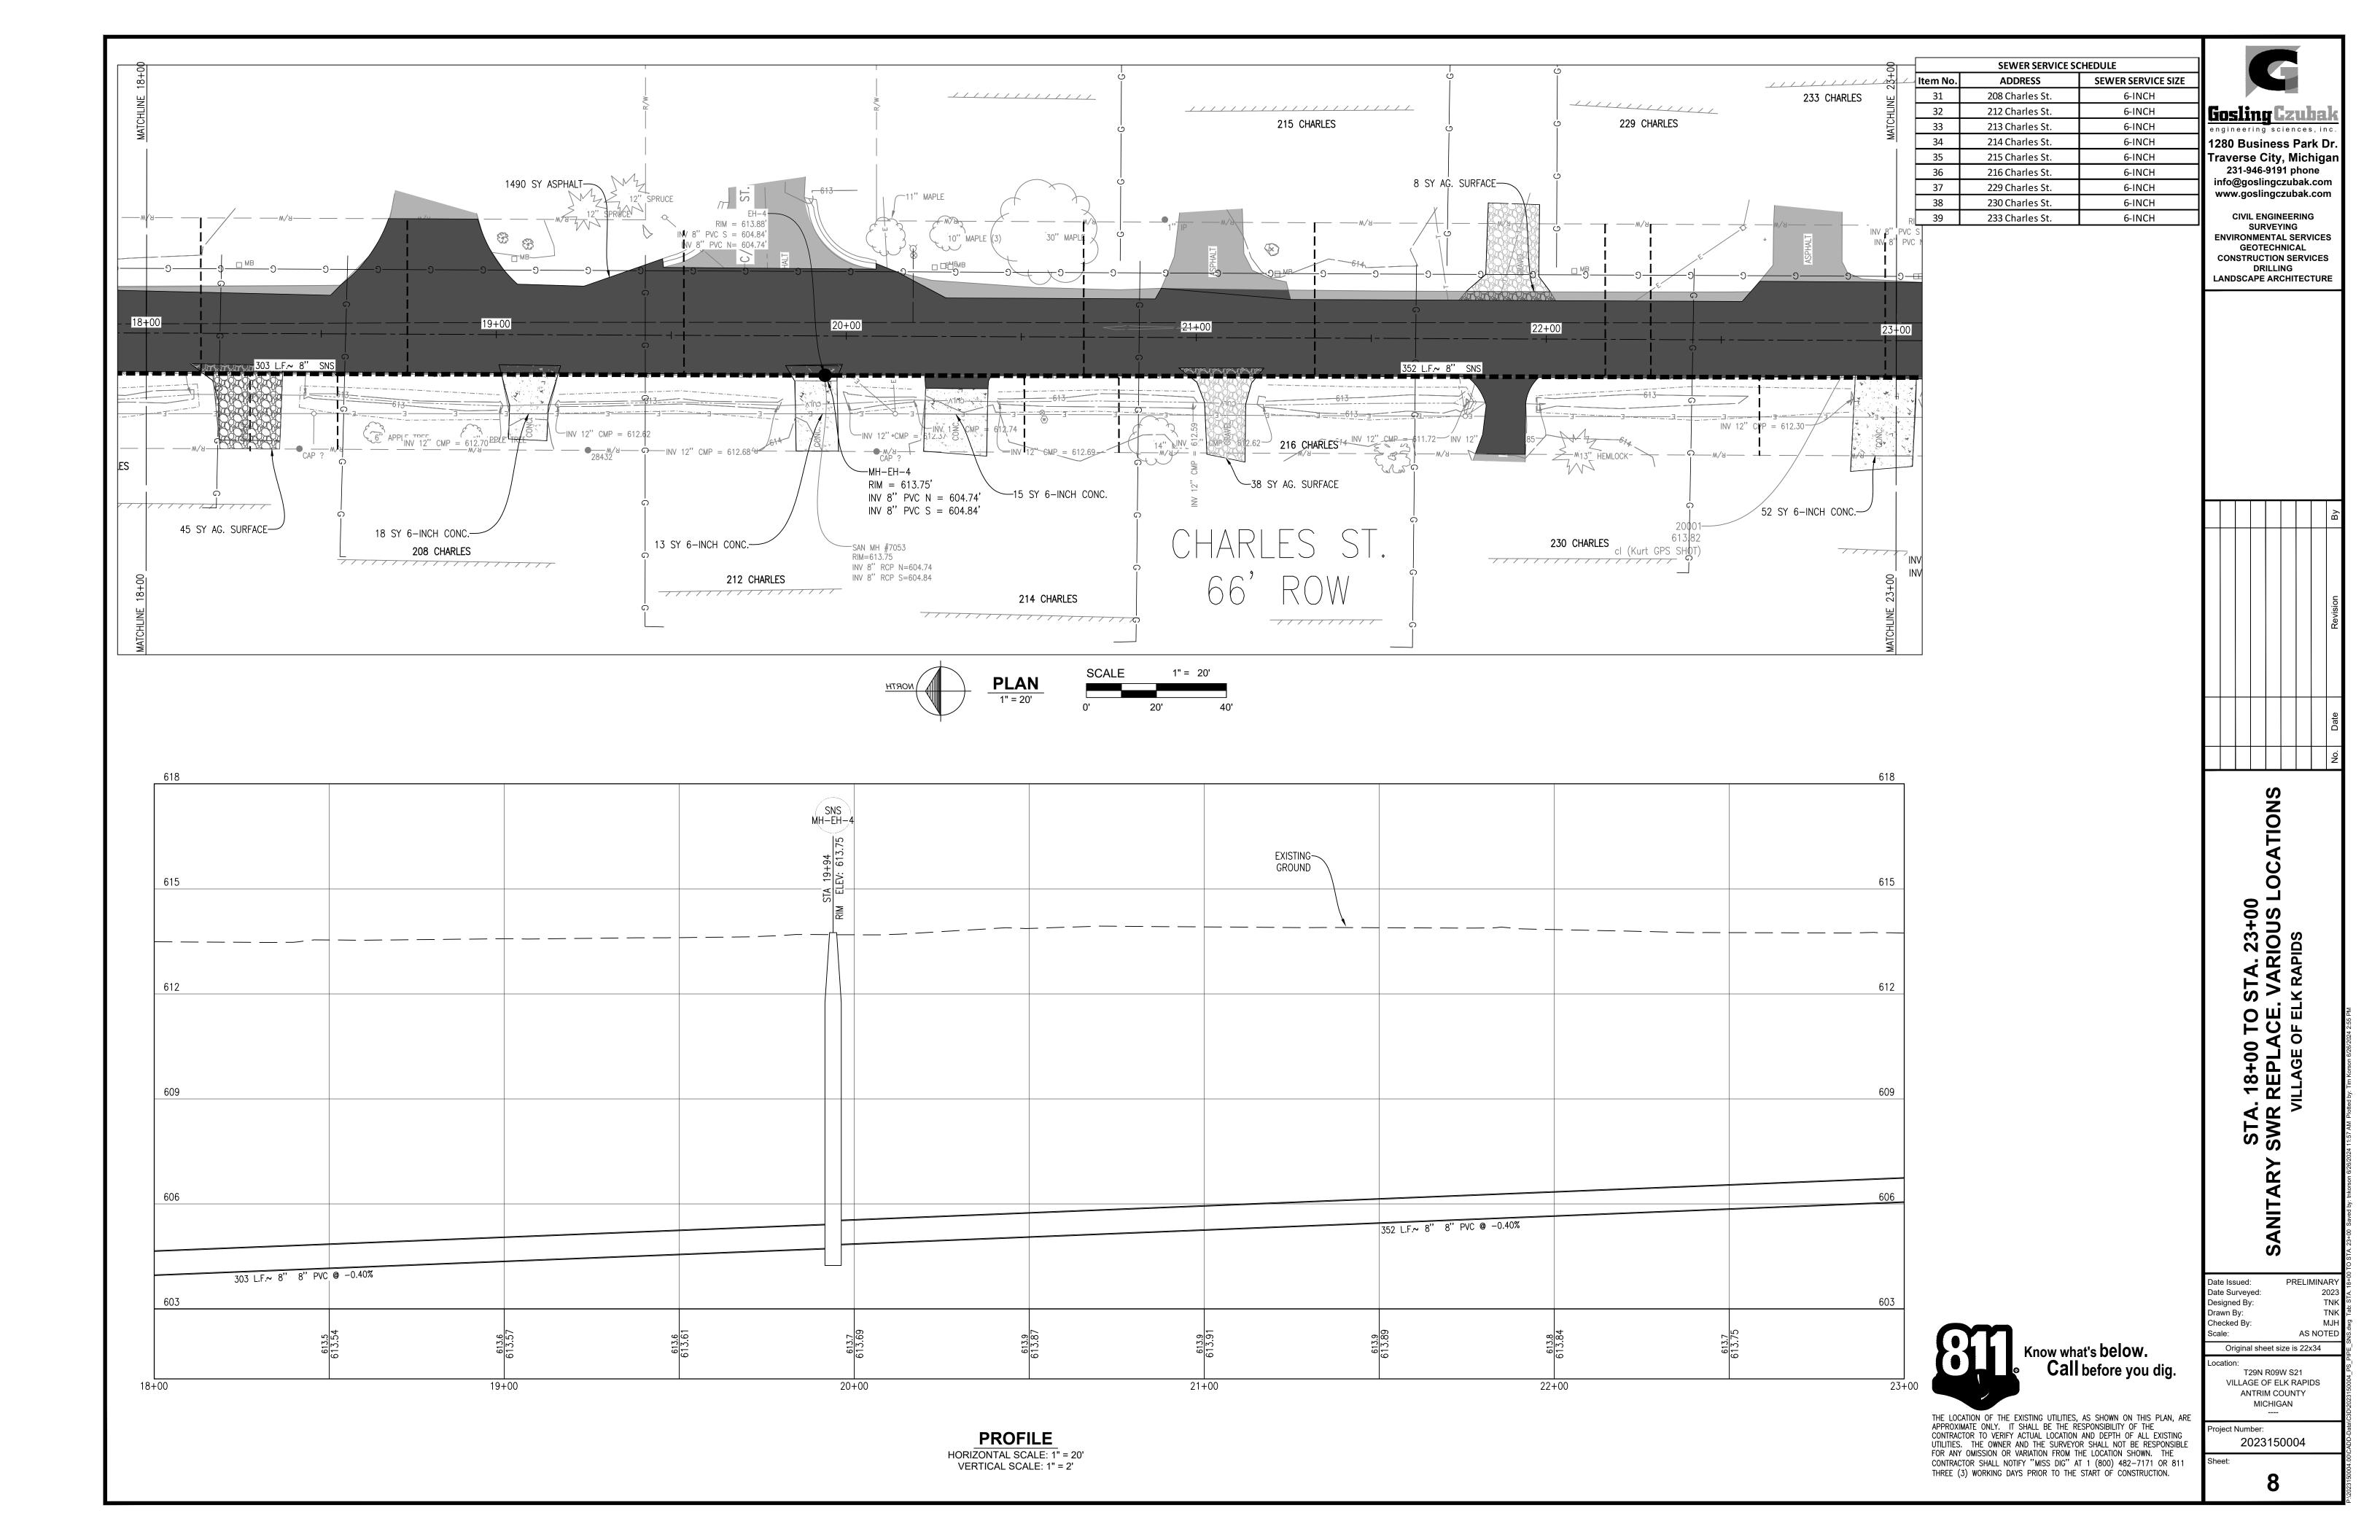

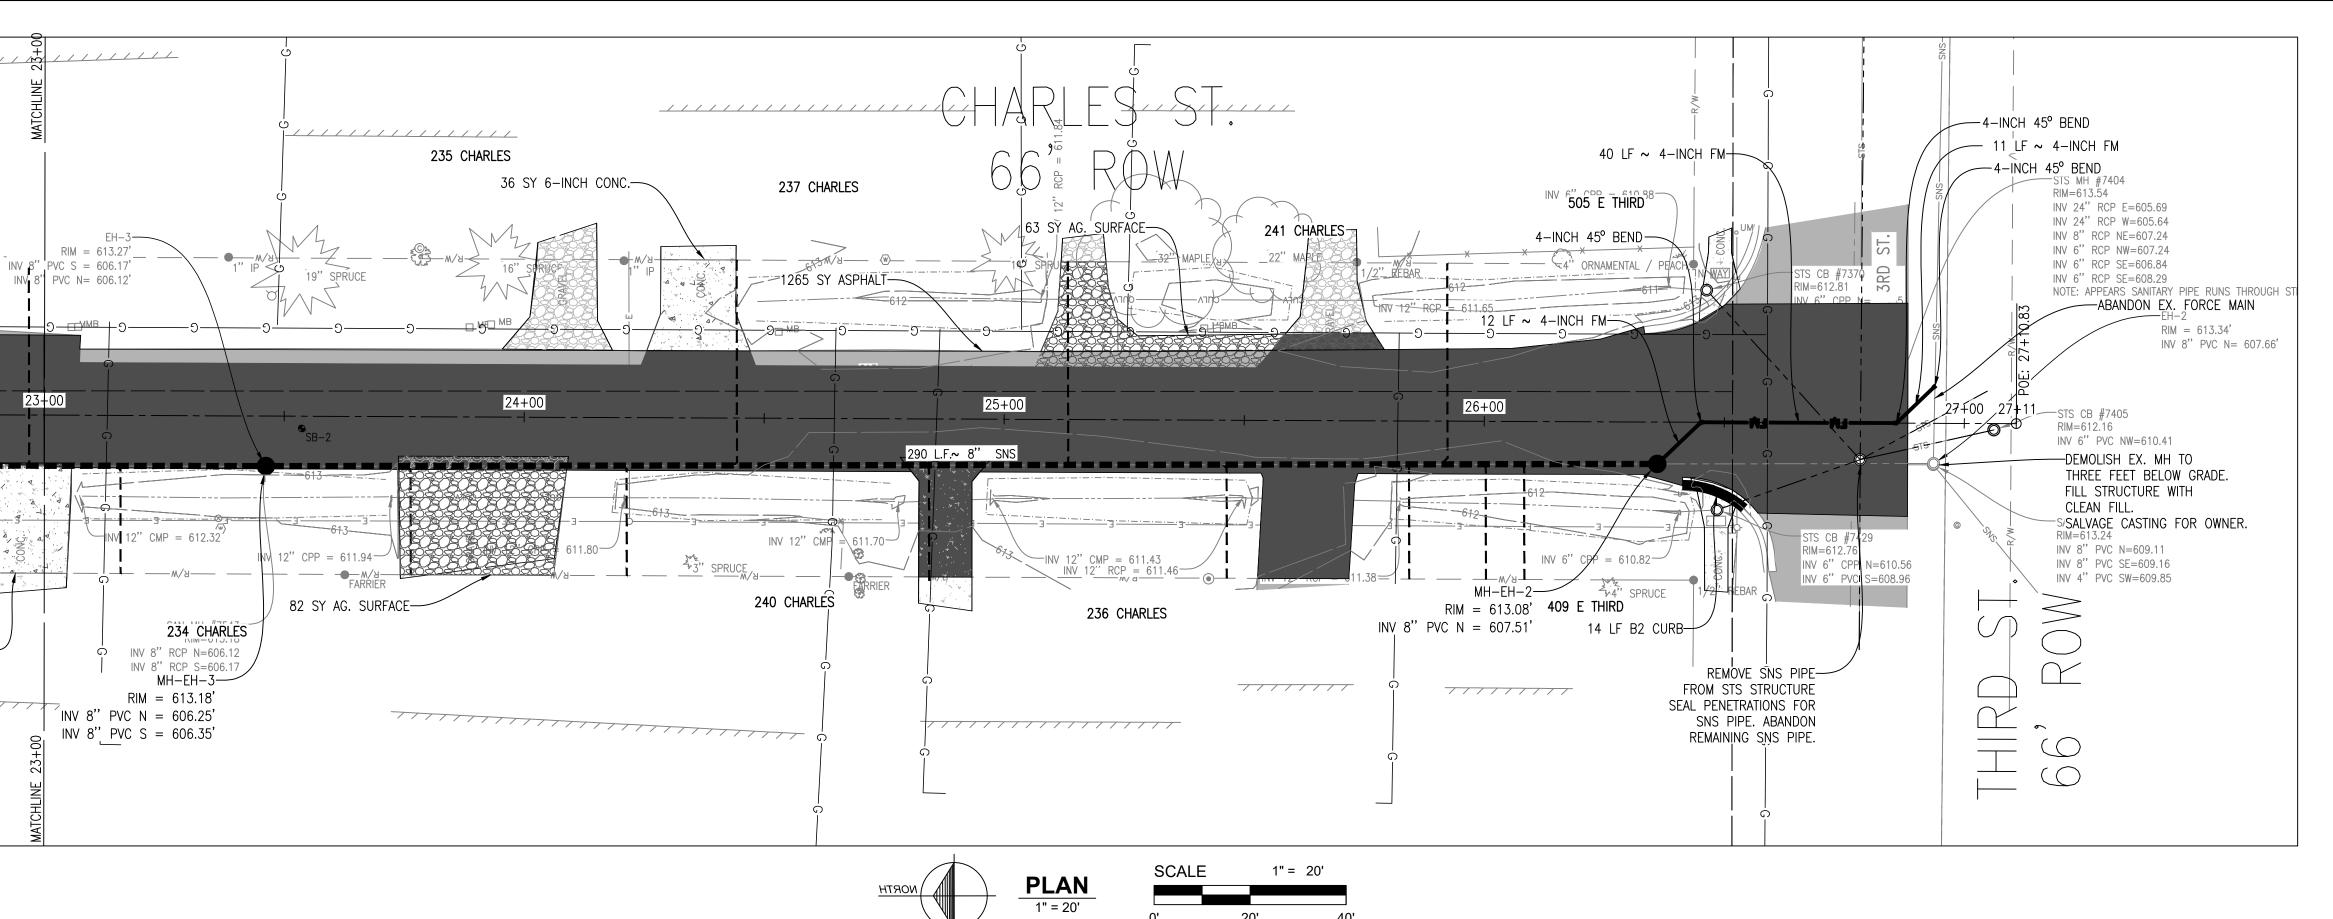

SEWER SERVICE SCHEDULE		
Item No.	ADDRESS	SEWER SERVICE SIZE
40	234 Charles St.	6-INCH
41	235 Charles St.	6-INCH
42	236 Charles St.	6-INCH
43	237 Charles St.	6-INCH
44	240 Charles St.	6-INCH
45	241 Charles St.	6-INCH
46	409 E 3rd St.	6-INCH

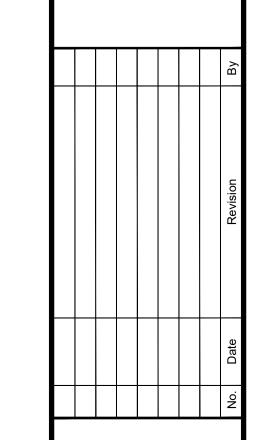

÷ S

0 TO STA. 27+1 ACE. VARIOUS OF ELK RAPIDS

Gosling Czubal

engineering sciences, inc

1280 Business Park Dr.

Traverse City, Michigar

231-946-9191 phone

info@goslingczubak.com

www.goslingczubak.com

CIVIL ENGINEERING

SURVEYING


**ENVIRONMENTAL SERVICES** 

GEOTECHNICAL

CONSTRUCTION SERVICES

DRILLING

LANDSCAPE ARCHITECTURE

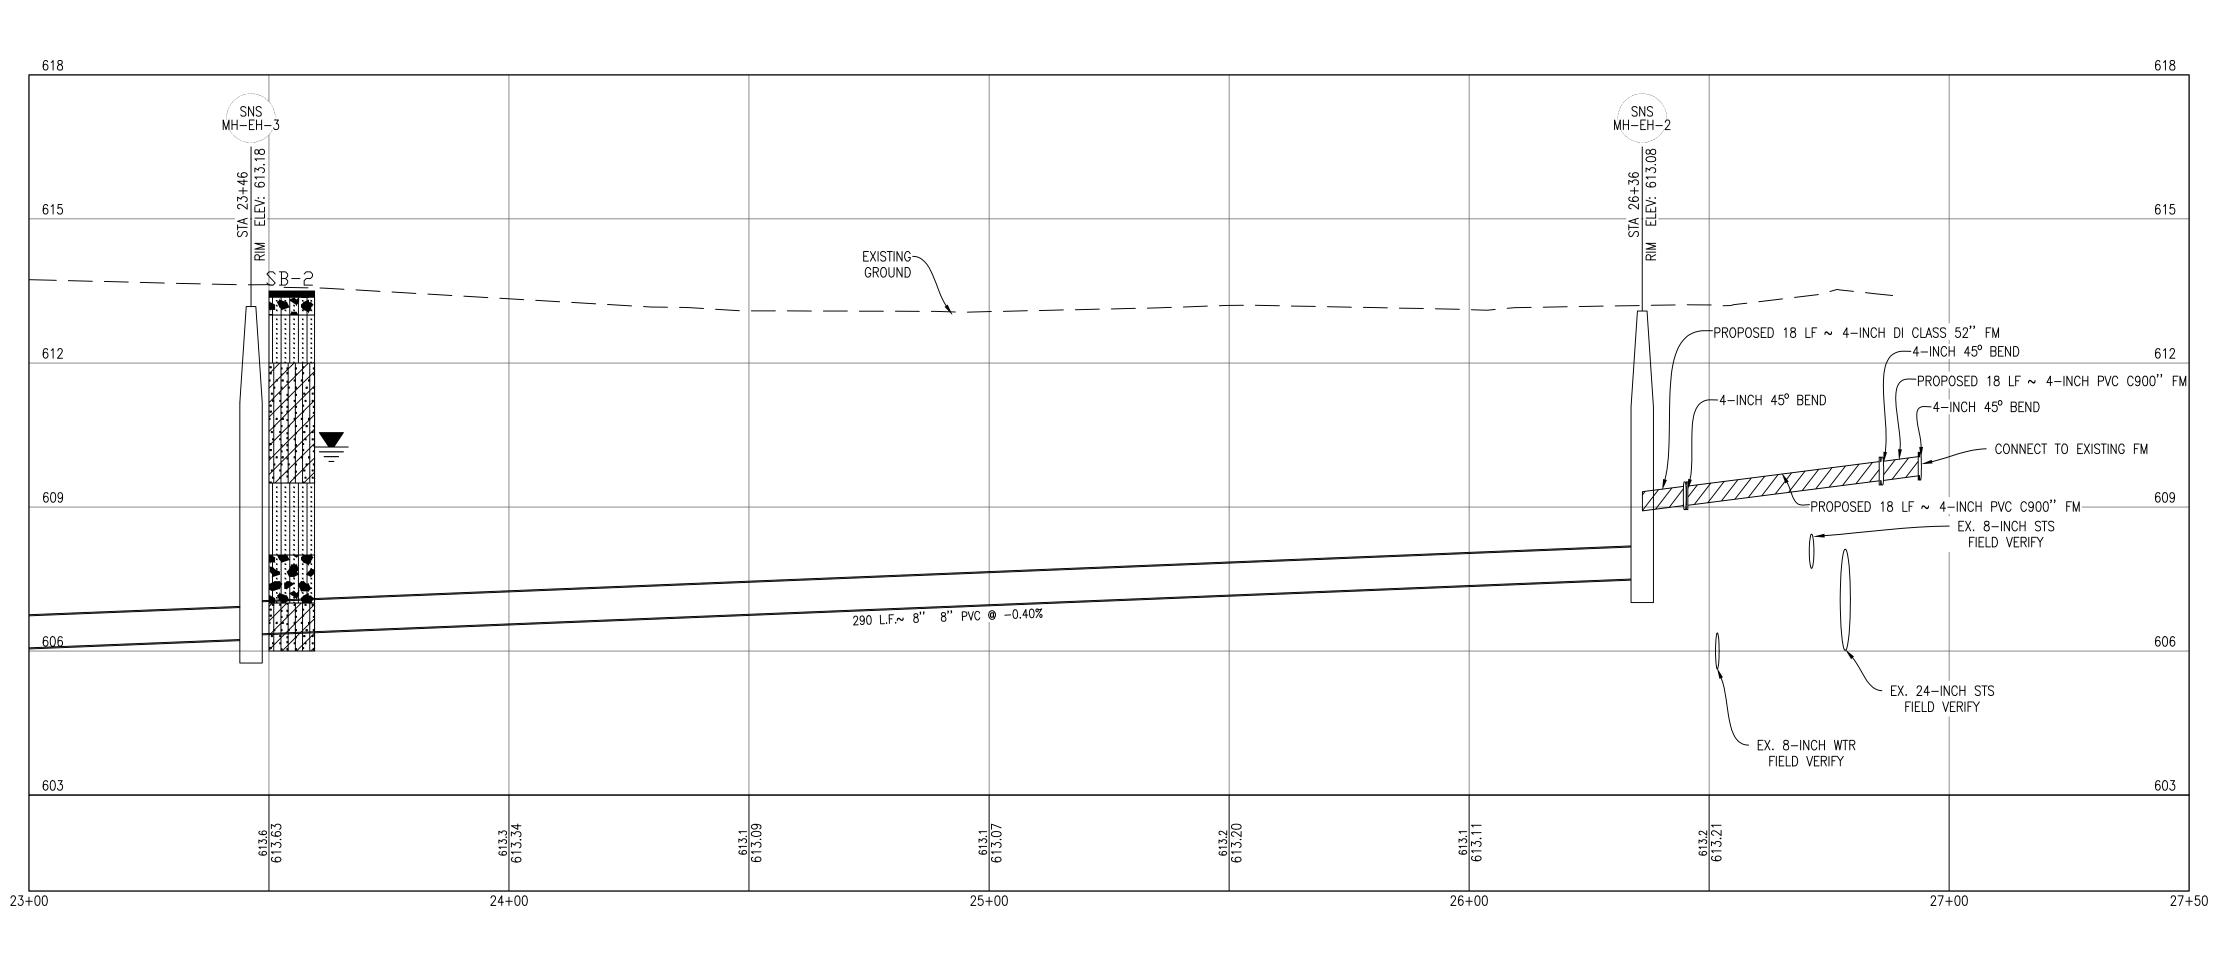



THE LOCATION OF THE EXISTING UTILITIES, AS SHOWN ON THIS PLAN, ARE APPROXIMATE ONLY. IT SHALL BE THE RESPONSIBILITY OF THE CONTRACTOR TO VERIFY ACTUAL LOCATION AND DEPTH OF ALL EXISTING UTILITIES. THE OWNER AND THE SURVEYOR SHALL NOT BE RESPONSIBLE FOR ANY OMISSION OR VARIATION FROM THE LOCATION SHOWN. THE CONTRACTOR SHALL NOTIFY "MISS DIG" AT 1 (800) 482-7171 OR 811 THREE (3) WORKING DAYS PRIOR TO THE START OF CONSTRUCTION.

Date Issued: Date Surveyed: Designed By: Drawn By: Checked By: Original sheet size is 22x34

T29N R09W S21 VILLAGE OF ELK RAPIDS ANTRIM COUNTY MICHIGAN


PRELIMINARY

AS NOTED

Project Number: 2023150004

9

**PROFILE** HORIZONTAL SCALE: 1" = 20' VERTICAL SCALE: 1" = 2'

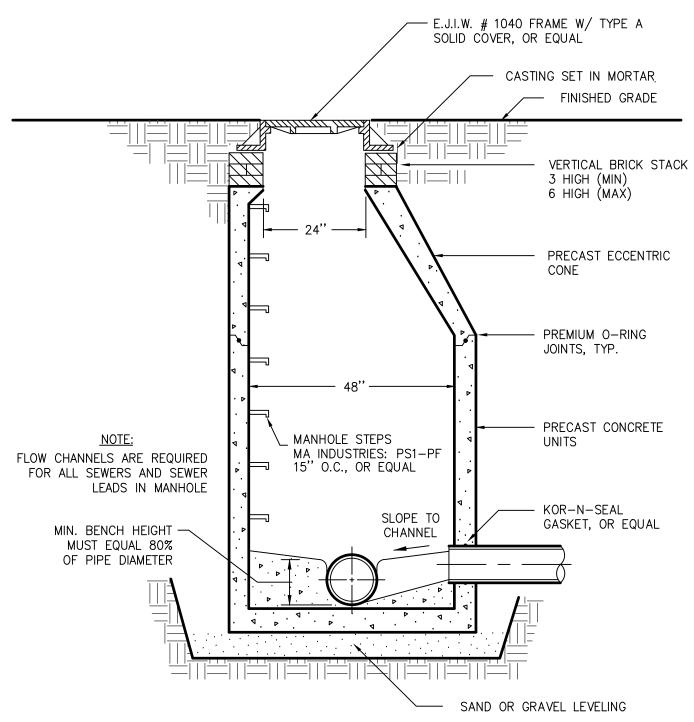

# SANITARY MANHOLE DETAIL NOT TO SCALE

NOTE: DO NOT CUT 4"X4" WOOD POST UNTIL RECORD ELEVATIONS ARE OBTAINED

APPROVED STOPPER OR PLUG

SAWCUT EX. — PAVEMENT

EX. PAVEMENT

6"-22A AGGREGATE -BASE, C.I.P.

NOTES:

CLEAN COMPACTED SAND FILL —
(USE FOR BACKFILL UNDER
ALL PAVEMENT, SIDEWALK

AND CURBS)


1. COMPACT SAND FILL TO

2. USE METHOD I FOR ALL

AND WATER MAINS.


95% MAX. DRY UNIT WEIGHT.

PLASTIC SANITARY SEWERS

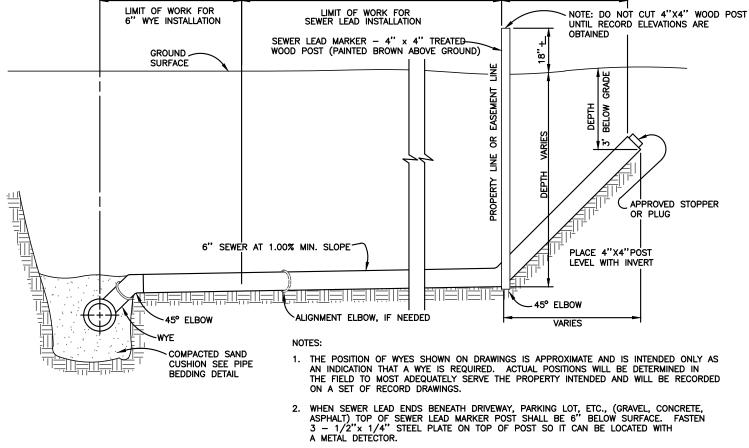

# WYE AND SEWER LEAD INSTALLATION DETAIL

NO SCALE

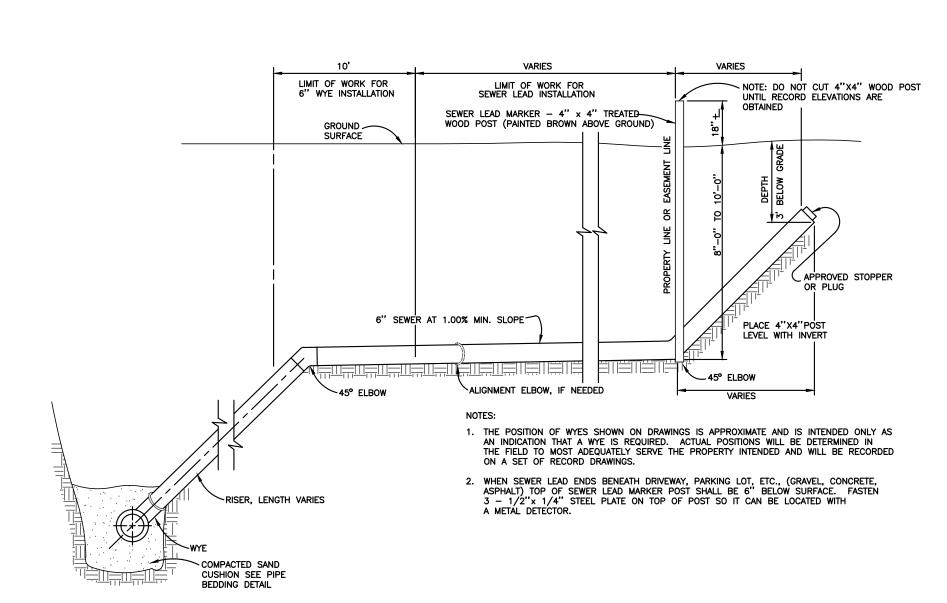

UNDER PAVEMENT

— DAMAGED – PAVEMENT

D + 16" MIN.

── 3" BITUMINOUS PAV'T

IN TWO COURSES

SHAPE TO FIT – PIPE BARREL

METHOD I

IN SAND AND GRAVEL

TRENCH DETAIL

NOT TO SCALE

IN UNPAVED AREA

METHOD II

IN CLAY, HARDPAN, ROCK
& FOR PLASTIC SANITARY

SEWERS & WATER MAINS


- FINISHED GRADE

--- EXCAVATED MATERIAL

COMPACTED ASTM D2321

PIPE BEDDING AND

INITIAL BACKFILL

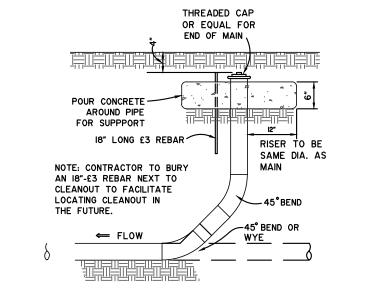

# **6" OR 8" CLEANOUT DETAIL**

NO SCALE

# DEEP SEWER WYE AND SEWER LEAD INSTALLATION DETAIL

NO SCALE



1280 Business Park Dr.
Traverse City, Michigan
231-946-9191 phone
info@goslingczubak.com
www.goslingczubak.com

CIVIL ENGINEERING
SURVEYING
ENVIRONMENTAL SERVICES
GEOTECHNICAL
CONSTRUCTION SERVICES
DRILLING

LANDSCAPE ARCHITECTURE

No. Date Revision By

DETAILS
SANITARY SWR REPLACE. VARIOUS LOCATIONS
VILLAGE OF ELK RAPIDS

Designed By: TNM
Drawn By: TNM
Checked By: MJH
Scale: AS NOTED
Original sheet size is 22x34

Location:
T29N R09W S21
VILLAGE OF ELK RAPIDS

12/3/2021

Date Surveyed:

ANTRIM COUNTY MICHIGAN

2023150004

10